

ROADWAY/STORM SEWER PLAN and PROFILE-CLAY STREET ROADWAY/STORM SEWER PLAN and PROFILE-COURTHOUSE BLVD. ROADWAY/STORM SEWER PLAN and PROFILE-COURTHOUSE BLVD. BRIDGE CURB AND SIDEWALK LAYOUT EAST SIDE BRIDGE RAILING LAYOUT AND PROFILE WEST SIDE BRIDGE RAILING LAYOUT AND PROFILE GIBSON CREEK BRIDGE RSP DETAILS LID PLANS-CLAY STREET AND RR TRACKS STORM WATER DETAILS STREET CENTERLINE AND ROADWAY LAYOUT PLAN CROSS SECTIONS—CLAY STREET—STA: 7+25 TO 9+75 CROSS SECTIONS—CLAY STREET—STA: 10+00 TO 12+75 CROSS SECTIONS-COURTHOUSE BLVD.-STA: 1+25 TO 3+75 CROSS SECTIONS-COURTHOUSE BLVD.-STA: 4+00 TO 6+00 CROSS SECTION-COURTHOUSE BLVD.-STA: 6+25 TO 8+25 OVERALL WATER PLAN SANITARY SEWER PLAN AND PROFILE-CLAY STREET SANITARY SEWER PLAN and PROFILE-COURTHOUSE BLVD. SANITARY SEWER PLAN and PROFILE-COURTHOUSE BLVD. WATER DETAILS SANITARY SEWER DETAILS SIGNING AND STRIPING PLAN <u>LOW IMPACT DEVELOPMENT (LID)</u> — GHD ENGINEERS 11 of 29 STORM WATER LID PLANS STORM WATER LID DETAILS TRAFFIC SIGNAL SHEETS - GHD ENGINEERS TRAFFIC SIGNAL PLAN TRAFFIC SIGNAL SCHEDULE GIBSON CREEK BRIDGE SHEETS - NRV GENERAL NOTES 1 of 7 DECK CONTOURS 2 of 7 FOUNDATION PLANS 3 of 7 ABUTMENT LAYOUT 4 of 7 ABUTMENT DETAILS NO. 1 5 of 7 GIRDER DETAILS NO. GIRDER DETAILS NO. 2 ELECTRICAL SHEETS - CITY OF UKIAH COVER, NOTES AND DETAIL SHEET 1 of 4 SUBSTRUCTURE PLAN





VICINITY MAP OWNER: NORTH COAST RAILROAD AUTHORITY APN: 002-232-15 and 002-282-20

CLEVELAND LANE

AND ASSOCIATES INC. CIVIL ENGINEERS · LAND SURVEYORS 100 NORTH PINE STREET • (707) 462-6536 • UKIAH, CA 95482

3 of 4

COVER SHEET

GEORGE C. RAU. R.C.E. 21908

**CERTIFICATION:** 

JULY 2017 SHEET Scale: AS SHOWN M.A.W G.C.R. Reviewed: G.C.R.

DATE

EXP. 09/30/17

SHEETS

REVISION: BY: COMPUTER NO: SERVER 2:\k1\
7 REVISIONS TO TYPICAL SECTIONS/VOLUMES MAW PATH: \DRAWNGS\CML\FINAL 7 RAISE SD BY 1'±, MOVE CLAY ST CURB INLETS MAW FILE: R11003.5\_Cover\_Sht\_FINAL.dwg /18/17 RAISE CLAY ST./COURTHOUSE BLVD 0.2±, MAW 27/17 WATER TO SS PROFILE-RAISE MH#1,ADD LATERALS MAW 0/6/17 AS-BUILT FIBER OPTIC, LOWER WATERLINE TO MISS MAW

26/18 FINAL CONSTRUCTION PLANS

BY: COMPUTER NO: SERVER Z:\R11003.5 VERIFY SCALE USE OF THIS DOCUMENT, INCLUDING THE INCORPORATED DESIGNS, IS AN INSTRUMENT OF SERVICE FOR THIS PROJECT WITHOU SHALL NOT BE USED FOR ANY OTHER PROJECT WITHOU THE WRITTEN AUTHORIZATION OF RAU AND ASSOCIATES INC.

309 EAST PERKINS STREET UKIAH, CA 95482

PROJECT: COURTHOUSE INFRASTRUCTURE PROJECT FINAL CONSTRUCTION

SUBSTRUCTURE PLAN

STREET LIGHT PLAN AND DETAILS

I CERTIFY THAT THIS PROJECT WAS DESIGNED BY ME OR

UNDER MY DIRECTION IN ACCORDANCE WITH GENERALLY ACCEPTED ENGINEERING PRACTICES

## CONSTRUCTION GENERAL NOTES

- ALL CONSTRUCTION SHALL CONFORM TO THE CITY OF UKIAH (HEREAFTER "CITY") SPECIFICATIONS, CITY OF UKIAH STANDARD DRAWINGS, AND THE PROJECT PLANS.
- THE CONTRACTOR SHALL PROVIDE, PROCURE AND PAY FOR ALL PERMITS REQUIRED TO CARRY ON AND COMPLETE THE WORK. THESE INCLUDE, BUT ARE NOT LIMITED TO, ENCROACHMENT PERMITS, CURRENT BUSINESS LICENSE, AND VALID AND PROPER CONTRACTOR'S LICENSE, ENCROACHMENT PERMITS MUST BE LOCATED ON THE JOB SITE DURING WHICH TIME CONTRACTOR IS WORKING THERE
- 3. CONTRACTOR SHALL NOTIFY UNDERGROUND SERVICE ALERT (U.S.A.) TWO (2) WORKING DAYS PRIOR TO ANY EXCAVATION. DIAL (TOLL FREE) 1-800-642-2444.
- ANY AND ALL INSPECTION FEES SHALL BE DUE AND PAYABLE TO THE CITY
- 5. CONSTRUCTION MATERIALS AND EQUIPMENT SHALL BE NEW AND OF A QUALITY EQUAL TO THAT SPECIFIED OR APPROVED. WORK SHALL BE DONE AND COMPLETED IN A THOROUGH AND WORKMANLIKE MANNER.
- 6. WHENEVER ANY MATERIAL OR EQUIPMENT IS INDICATED OR SPECIFIED BY PATENT OR PROPRIETARY NAME OR BY THE NAME OF THE MANUFACTURER, SUCH OR PROPHIEIARY NAME OR BY THE NAME OF THE MANUFACTURER, SUCH SPECIFICATION SHALL BE CONSIDERED AS USED FOR DESCRIBING THE MATERIAL OR EQUIPMENT DESIRED AND SHALL BE CONSIDERED AS FOLLOWED BY THE WORDS "OR APPROVED EQUIVALENT". THE CONTRACTOR MAY OFFER ANY MATERIAL OR EQUIPMENT WHICH SHALL BE SUBSTANTIALLY EQUIVALENT IN EVERY RESPECT TO THAT SPECIFIED, PROVIDED THAT WRITTEN APPROVAL IS FIRST OBTAINED FROM
- MATERIALS SHALL BE SO STORED TO ENSURE THE PRESERVATION OF THEIR QUALITY AND FITNESS FOR THE WORK. THEY SHALL BE SO LOCATED AND DISPOSED THAT PROMPT AND PROPER INSPECTION THEREOF MAY BE MADE.
- THE CITY SHALL HAVE THE RIGHT TO TAKE POSSESSION OF AND USE ANY COMPLETED OR PARTIALLY COMPLETED PORTIONS OF THE WORK, NOTWITHSTANDING THE TIME FOR COMPLETING THE ENTIRE WORK OR SUCH PORTIONS WHICH MAY NOT HAVE EXPIRED; BUT SUCH TAKING POSSESSION AND USE SHALL NOT BE DEEMED AN ACCEPTANCE OF ANY WORK NOT COMPLETED IN ACCORDANCE WITH THE PROJECT PLANS. IF SUCH PRIOR USE INCREASES THE COST OF OR DELASE THE WORK THE CONTROL OF SHALL BE ENTIRED TO SUCH PARTY. DELAYS THE WORK, THE CONTRACTOR SHALL BE ENTITLED TO SUCH EXTRA COMPENSATION OR EXTENSION OF TIME, OR BOTH, AS THE NCRA DETERMINE.

## WATER CONSTRUCTION NOTES

- 1. ALL CONSTRUCTION SHALL CONFORM TO THE CITY OF UKIAH SPECIFICATION, CITY OF UKIAH STANDARD DRAWINGS, CALIFORNIA PLUMBING CODE (LATEST
- 2. CONTRACTOR SHALL NOTIFY UNDERGROUND SERVICE ALERT (U.S.A.) TWO (2) WORKING DAYS PRIOR TO ANY EXCAVATION. DIAL (TOLL FREE)
- 3. ALL CONNECTIONS TO LIVE WATER MAINS SHALL BE MADE BY CITY FORCES, AT NCRA EXPENSE.
- 4. AT THE LOCATION OF EACH WATER AND SEWER SERVICE LATERAL, THE LETTERS "W" FOR WATER AND "S" FOR SEWER SHALL BE INSCRIBED INTO THE FACE OF THE CURB. THE LETTERS "W" AND "S" SHALL BE 4" HIGH AND COMPLETELY
- 5. METER BOXES AND VAULTS SHALL BE LOCATED OUT OF TRAFFIC LOADING AREAS WHENEVER POSSIBLE AND SET SO THAT THE LIDS ARE CENTERED OVER THE

## SEWER CONSTRUCTION NOTES

- CONTRACTOR SHALL NOTIFY UNDERGROUND SERVICE ALERT (U.S.A.) TWO (2) WORKING DAYS PRIOR TO ANY EXCAVATION. DIAL TOLL FREE 1-800-642-2444.
- ALL SEWER TAPS INTO LIVE MANHOLES OR MAINS SHALL BE MADE BY THE CITY, AT THE NCRA EXPENSE, UNLESS OTHER ARRANGEMENTS HAVE BEEN APPROVED.
- 3 NEW SEWER MAINS ARE TO BE CLEANED AND FREE OF DEBRIS. BY MEANS OF AN APPROVED METHOD (E.G. RUBBER BALL WASHED THROUGH HYDRO-CLEANER, ETC.) PRIOR TO TESTS FOR LEAKAGE AND DEFLECTION.
- 4. PIPE DEFLECTION SHALL BE TESTED BY USE OF A STEEL MANDREL, WITH MAXIMUM ALLOWABLE DEFLECTION OF 5%. CONTRACTOR SHALL PROVIDE A STEEL MANDREL AT THE JOB SITE, FOR EVERY DIAMETER OF SEWER MAIN
- SEWER MAINS SHALL BE TESTED FOR SOUNDNESS AND TIGHTNESS (LEAKAGE) BY THE USE OF LOW-PRESSURE AIR TEST OR A HYDROSTATIC TEST WITH A MINIMUM OF 10' OF HEAD AND ANY PORTION OF THE MAIN TO BE TESTED. CONTRACTOR SHALL HAVE ON—SITE, A MEANS BY WHICH TO TEST THE MAIN.
- MANHOLES SHALL BE COATED INSIDE WITH ONE (1) COAT OF THORO—SEAL, XYPEX OR APPROVED EQUAL.
- 7. MANHOLES SHALL BE SUBJECT TO HYDROSTATIC TESTS, BY FILLING WITH WATER AND MEASURING THE DROP IN WATER LEVEL OVER A 30 MINUTE PERIOD. PRIOR TO THE 30 MINUTE TEST, MANHOLES SHALL BE FILLED WITH WATER FOR
- 8. ALL TRENCHES SHALL BE BACKFILLED IN ACCORDANCE WITH STANDARD DRAWING NO. 220 PRIOR TO TESTS FOR LEAKAGE AND DEFLECTION.
- 9. SEWER CONSTRUCTION IN PUBLIC RIGHT-OF-WAY AND ON SITE (EXCEPT THROUGHOUT THE BUILDING ITSELF) SHALL BE SUBJECT TO FIELD INSPECTIONS

# STREET STRUCTURAL SECTION NOTES

- DESIGN TRAFFIC INDEX = 8.0 MINIMUM R-VALUE TOP 0.5 FEET, SUBGRADE = 25 CLASS 2 AGGREGATE BASE R-VALUE = 78

# **CONTACT INFORMATION**

<u>CITY OF UKIAH</u> PUBLIC WORKS DEPARTMENT 300 SEMINARY DRIVE UKIAH, CA 95482 (707) 463-6280 TIM FRIKSEN

SURVEYING AND CIVIL ENGINEERING RAU AND ASSOCIATES, INC. 100 NORTH PINE STREET UKIAH. CA 95482 (707) 462-6536 GEORGE RAU

HYDROLOGY AND TRAFFIC 2235 MERCURY WAY, SUITE 150 SANTA ROSA, CA 95407 (707) 523-1010 MATT KENNEDY

GEOTECHNICAL ENGINEERING CRAWFORD AND ASSOCIATES, INC. 100 NORTH PINE STREET UKIAH, CA 95482 RYAN HOUGHTON (707) 240-4400

ELECTRICAL ENGINEERING CITY OF UKIAH ELECTRIC UTILITY DEPARTMENT UTILITY DESIGN SERVICES, LLC (707) 380-5803 ÀL ŚMATSKY


BRIDGE DESIGN

NRV 8350 MARINA GREENS WAY SACRAMENTO, CA 95826 (707)884-9551 ROBERT VALENTINE

## **ABBREVIATIONS**

AGGREGATE BASE ASPHALT CONCRETE ALTERNATE BEGIN VERTICAL CURVE ELEVATION BVCE BEGIN VERTICAL CURVE STATION CENTERLINE CONTROL POINT CORRUGATED METAL PIPE CORRUGATED POLYETHYLENE PIPE END VERTICAL CURVE ELEVATION END VERTICAL CURVE STATION EVCS ELEV FIEVATION EDGE OF PAVEMENT EXIST.(E) EXISTING FES FG FHWA FLARED FND SECTION FINISHED GRADE
FEDERAL HIGHWAY ADMINISTRATION F&C FRAME AND COVER FLOW LINE GRADE BREAK HIGH DENSITY POLYETHYLENE HDPE INVERT LINEAR FOOT Lt NTS OG (P) PC NOT TO SCALE ORIGINAL GROUND PROPOSED POINT OF CURVATURE PGL PCC PM PROPOSED GRADE LINE PORTLAND CEMENT CONCRETE PERMEABLE MATERIAL PMP PT PVI POINT OF TANGENT
POINT OF VERTICAL INTERSECTION PROPERTY LINE RCP Rt ROW REINFORCED CONCRETE PIPE RIGHT OF WAY SAW CUT
STATION
TEMPORARY CONSTRUCTION EASEMENT SC STA TCE TYP TYPICAL VARIABLE

## **EXISTING CONDITION LEGEND**

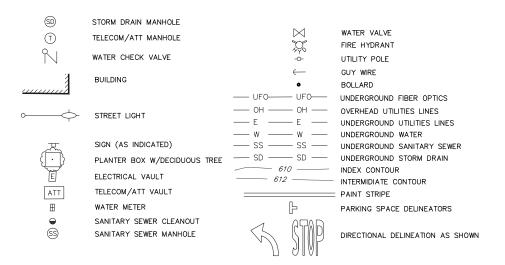



REVISION: BY:
REVISIONS TO TYPICAL SECTIONS/VOLUMES MAW RAISE SD BY 1'±, MOVE CLAY ST CURB INLETS MAW 7 RAISE CLAY ST./COURTHOUSE BLVD 0.2±, MAW /27/17 WATER TO SS PROFILE-RAISE MH#1,ADD LATERALS MAW 0/6/17 AS-BUILT FIBER OPTIC, LOWER WATERLINE TO MISS MAN 5/26/18 FINAL CONSTRUCTION PLANS

COMPUTER NO: SERVER Z:\R11003.5 PATH: \DRAWINGS\CIVIL\FINAL FILE: R11003.5 Cover Sht FINAL.dwg PSVIEW: SHT02 NOTE-SYMBOLS

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OWNER: NORTH COAST RAILROAD AUTHORITY APN: 002-232-15 and 002-282-20

309 EAST PERKINS STREET LOCATION: UKIAH, CA 95482



GENERAL NOTES AND SYMBOLS DRAWING

FINAL CONSTRUCTION

JULY 2017 SHEET Scale: AS SHOWN Drawn: M.A.V Checked: G.C.R. PROJECT: COURTHOUSE INFRASTRUCTURE PROJECT Reviewed: G.C.R Job No. R11003.5




THE FLEVATIONS SHOWN HEREON ARE BASED ON A BENCHMARK SURVEY DISK, ELEVATION=618.10' NGVD 1988, SET VERTICALLY IN THE WEST BRICK WALL OF THE DEPOT STATION BUILDING, 25.82' SOUTH OF NORTHWEST CORNER OF BUILDING AND 3.9' ABOVE FLOOR. IDENTIFIED AS KT1168 ON FEMA FLOOD INSURANCE RATE MAP PANEL 1514F: MENDOCINO COUNTY, CALIFORNIA AND INCORPORATED AREAS.
COMMUNITY NUMBER 060183 AND 060186; JUNE 2, 2011.

#### HORIZONTAL DATUM

COORDINATES ARE BASED ON RECORD OF SURVEY (ASSUMED)

Control Point Table							
Point #	Northing	orthing Easting Elevation Description		Description			
13	11,067.7164	9,468.2873	614.23	PK N&S_SET			
16	10,394.9693	9,580.8099	612.11	PK W/ SHINER			
20	10,684.6088	9,735.5271	611.25	60d N&S_SET			
28	11,013.9905	10,040.5411	610.54	PK N&S_SET			
30	10,393.5179	9,769.9854	609.49	1/2 IP			
31	10,216.3694	9,580.0064	611.52	PK			
32	10,788.1260	9,855.1254	610.13	1/2 IP			
33	10,973.5615	9,834.3496	611.98	PK			
34	11,165.6242	9,451.8035	614.72	PK North of Perkins			
41	10,926.2102	9,521.3964	614.09	PK N&S_SET			
43	11,002.7874	9,769.3733	611.98	PK N&S_SET			
44	11,079.8014	9,981.8659	610.75	60d N&S_SET			
45	10,837.5310	10,043.2332	611.02	PK N&S_SET			
46	10,341.5047	10,140.6534	608.96	PK N&S_SET			
2140	11,153.5353	10,009.2569	610.71	PK N&S_SET			
2141	11,043.4395	9,764.8275	611.74	PK N&S_SET			

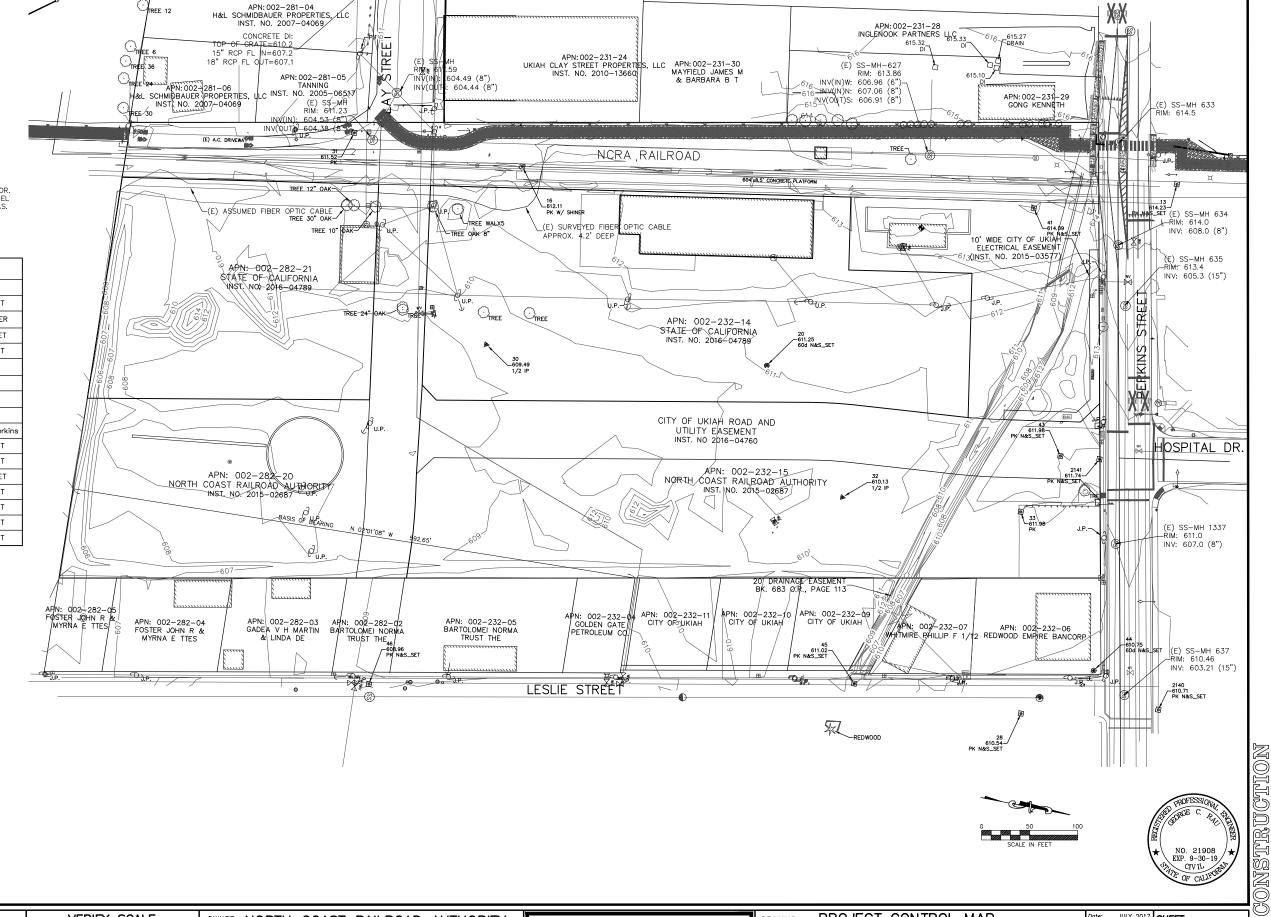

REVISION: BY: COMPUTER NO: SERVER Z:\
REVISIONS TO TYPICAL SECTIONS/VOLUMES MAW PATH: \DRAWINGS\CNIL 9/12/17 RAISE SD BY 1'±, MOVE CLAY ST CURB INLETS MAW FILE: R11003.3 Topo.dwg /27/17 WATER TO SS PROFILE-RAISE MH#1,ADD LATERALS MAW PSVIEW: 0/6/17 AS-BUILT FIBER OPTIC, LOWER WATERLINE TO MISS MAW MSVP:

VERIFY SCALE BAR REPRESENTS THREE INCHES ON ORIGINA USE OF THIS DOCUMENT, INCLUDING THE INCORPORATED DESIGNS, IS AN INSTRUMENT OF SERVICE FOR THIS PROJEC AND SHALL NOT BE USED FOR ANY OTHER PROJECT WITHOUT THE WRITTEN AUTHORIZATION OF RAU AND ASSOCIATES INC. OWNER: NORTH COAST RAILROAD AUTHORITY APN: 002-232-15 and 002-282-20

309 EAST PERKINS STREET

95482

UKIAH, CA

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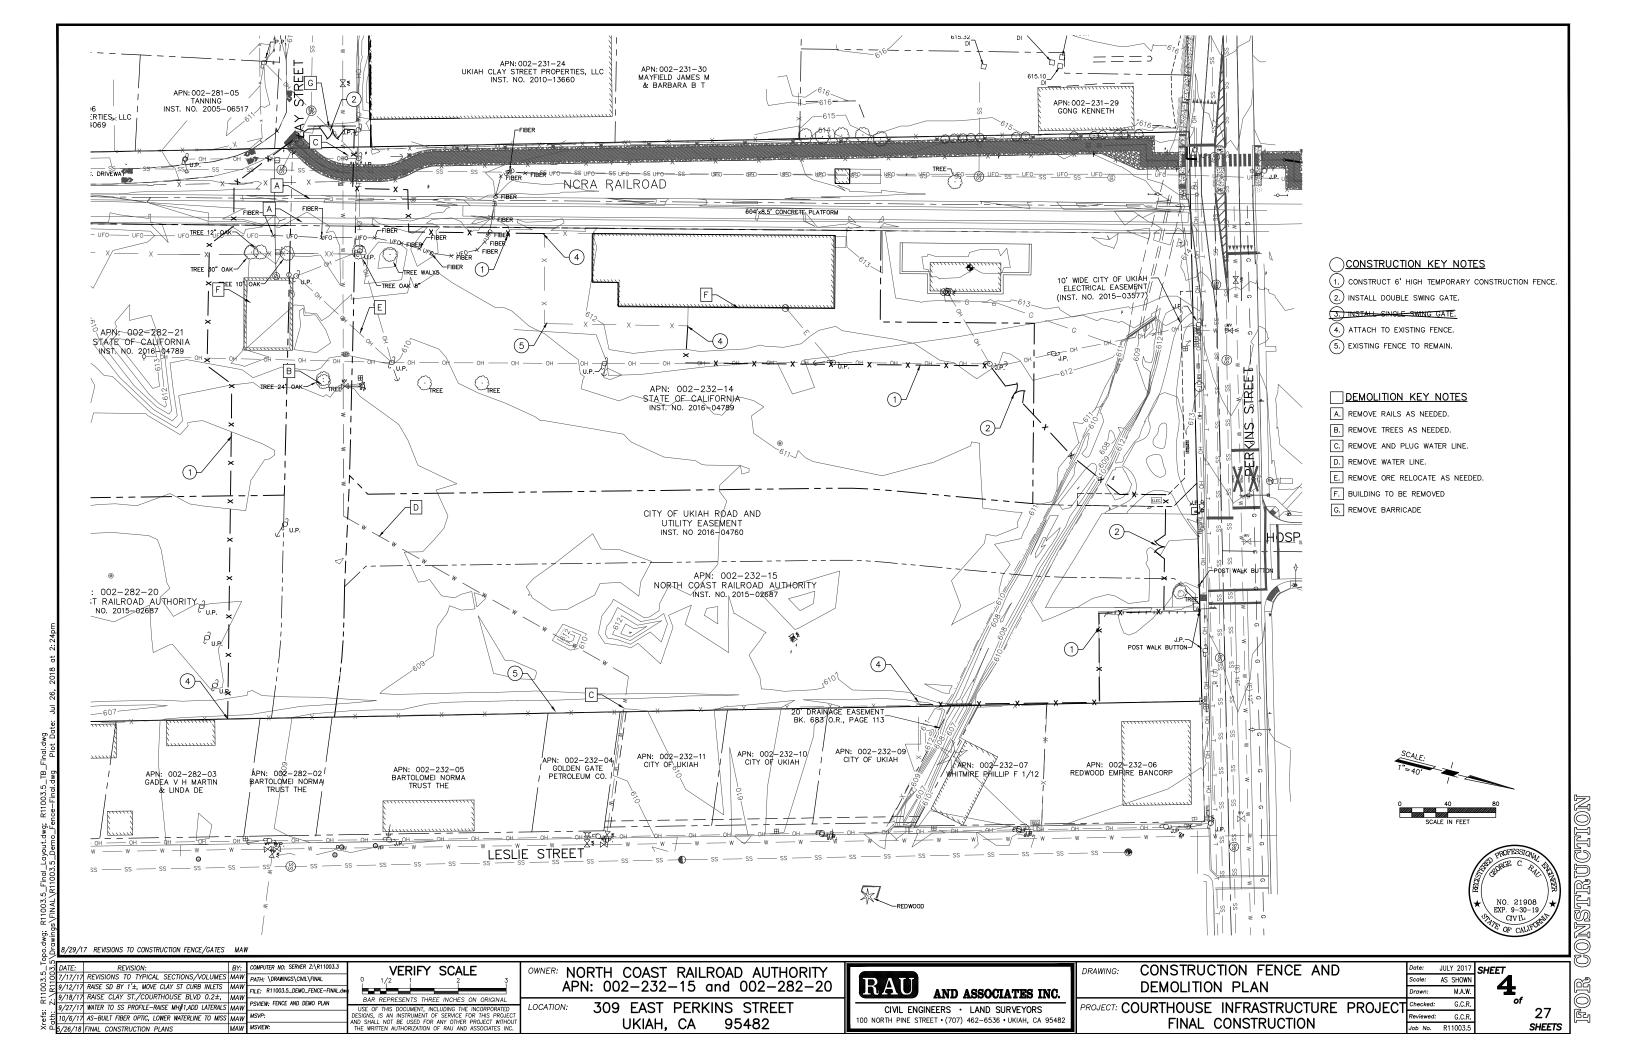
PROJECT CONTROL MAP DRAWING: **EXISTING CONDITIONS** PROJECT: COURTHOUSE INFRASTRUCTURE PROJECT


FINAL CONSTRUCTION


JULY 2017 SHEET Scale: AS SHOWN 3 M.A.W. G.C.R. Reviewed: G.C.R. Job No. R11003.5


27 SHEETS

LOCATION:



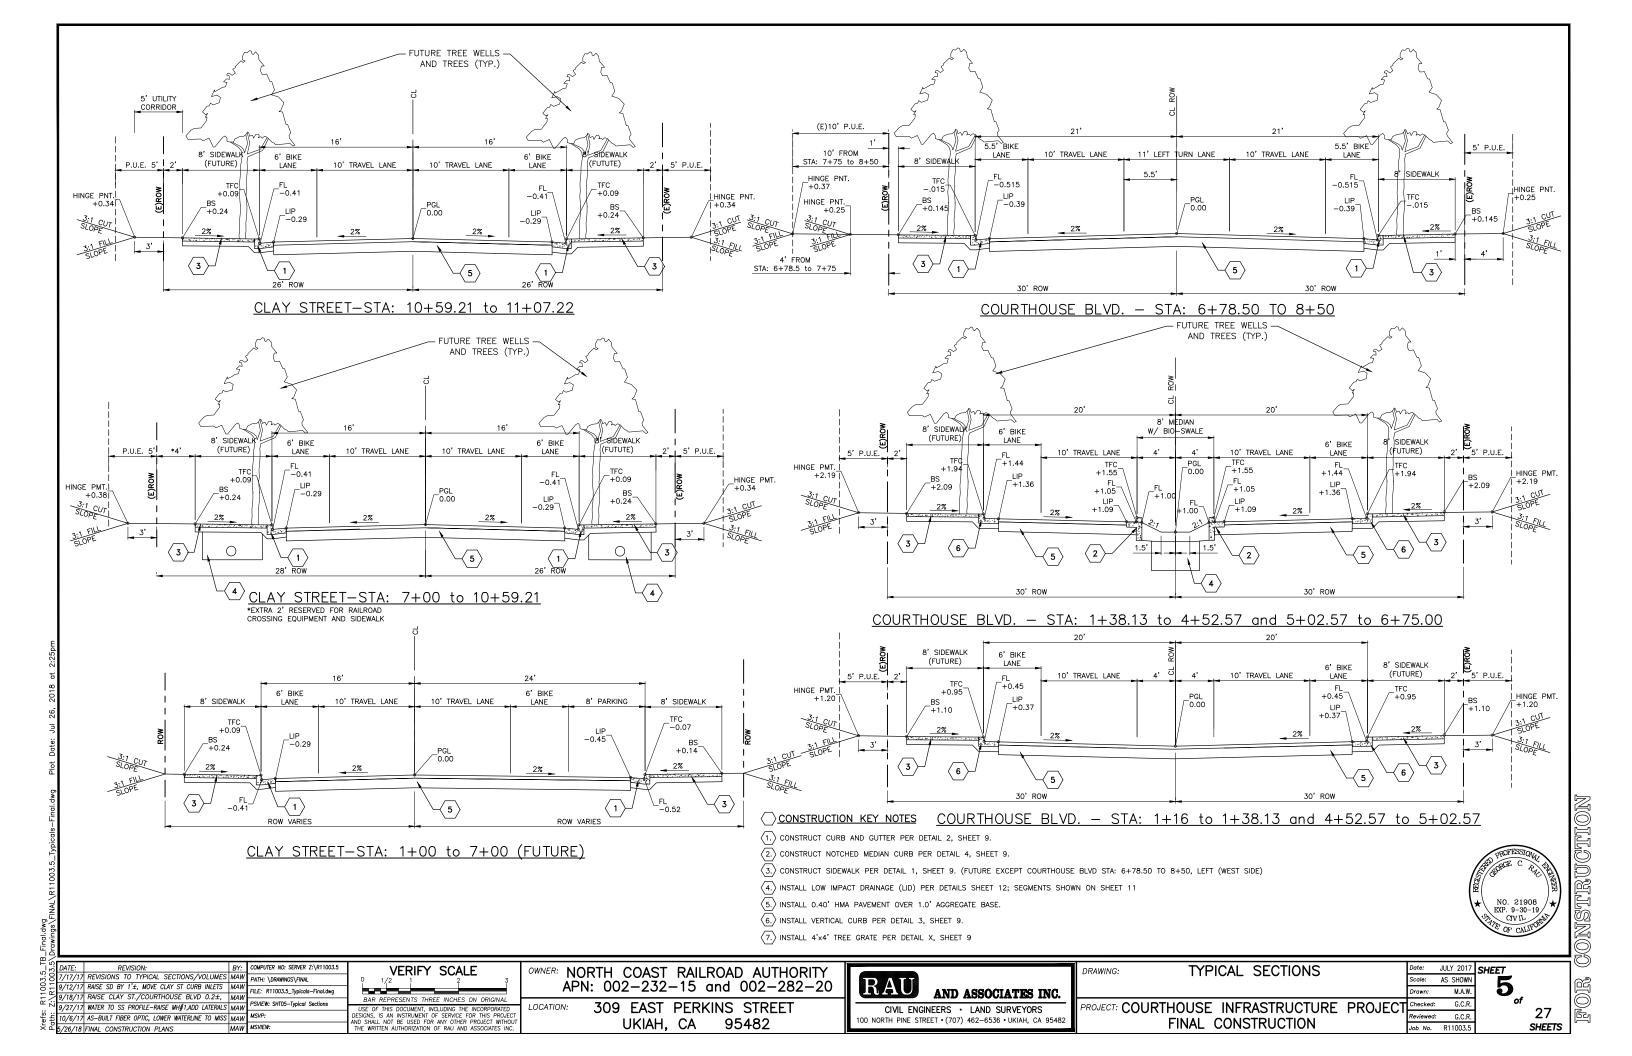

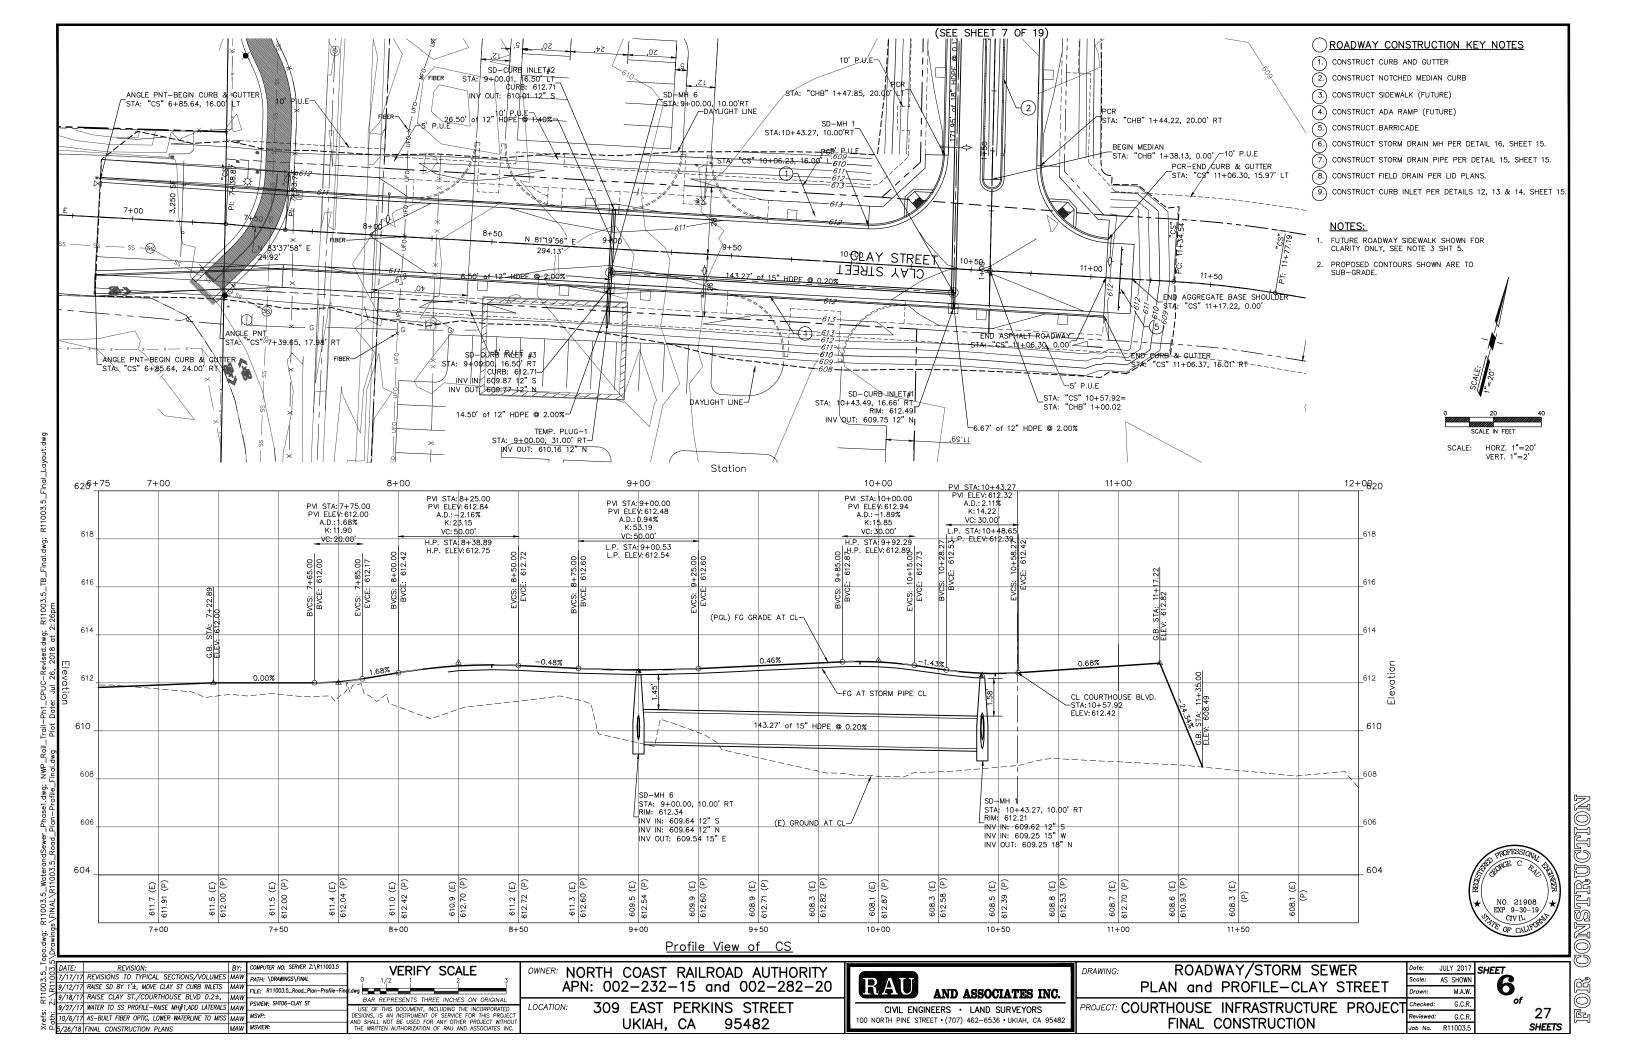

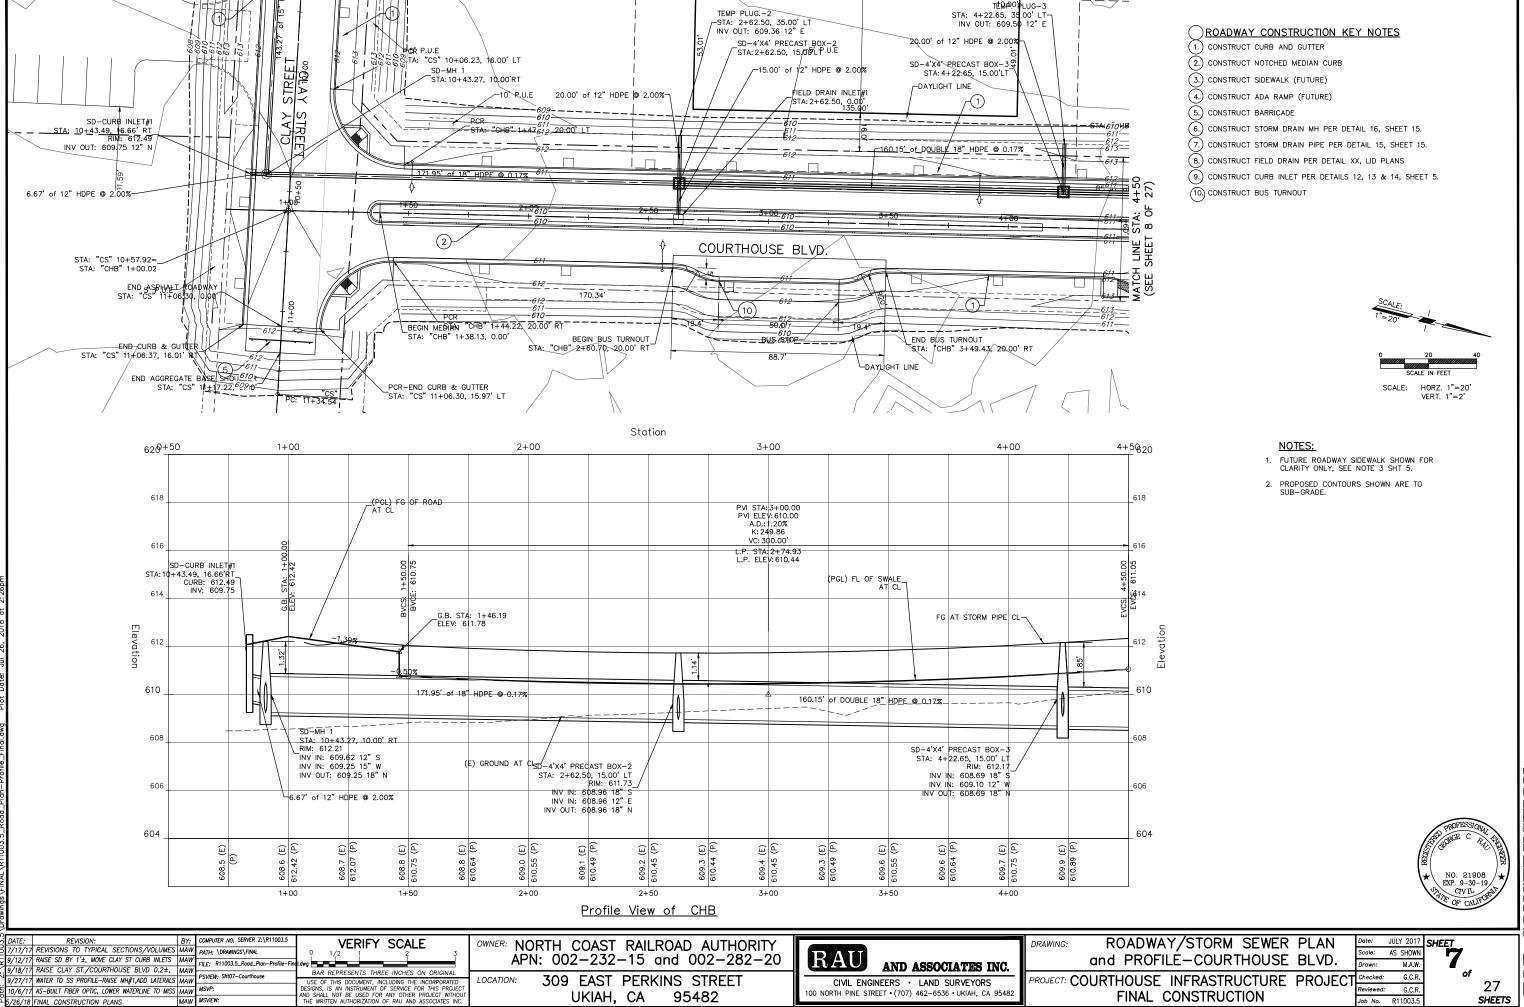

95482


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0/6/17 AS-BUILT FIBER OPTIC, LOWER WATERLINE TO MISS MAY


26/18 FINAL CONSTRUCTION PLANS


SHEETS

Reviewed: G.C.R.

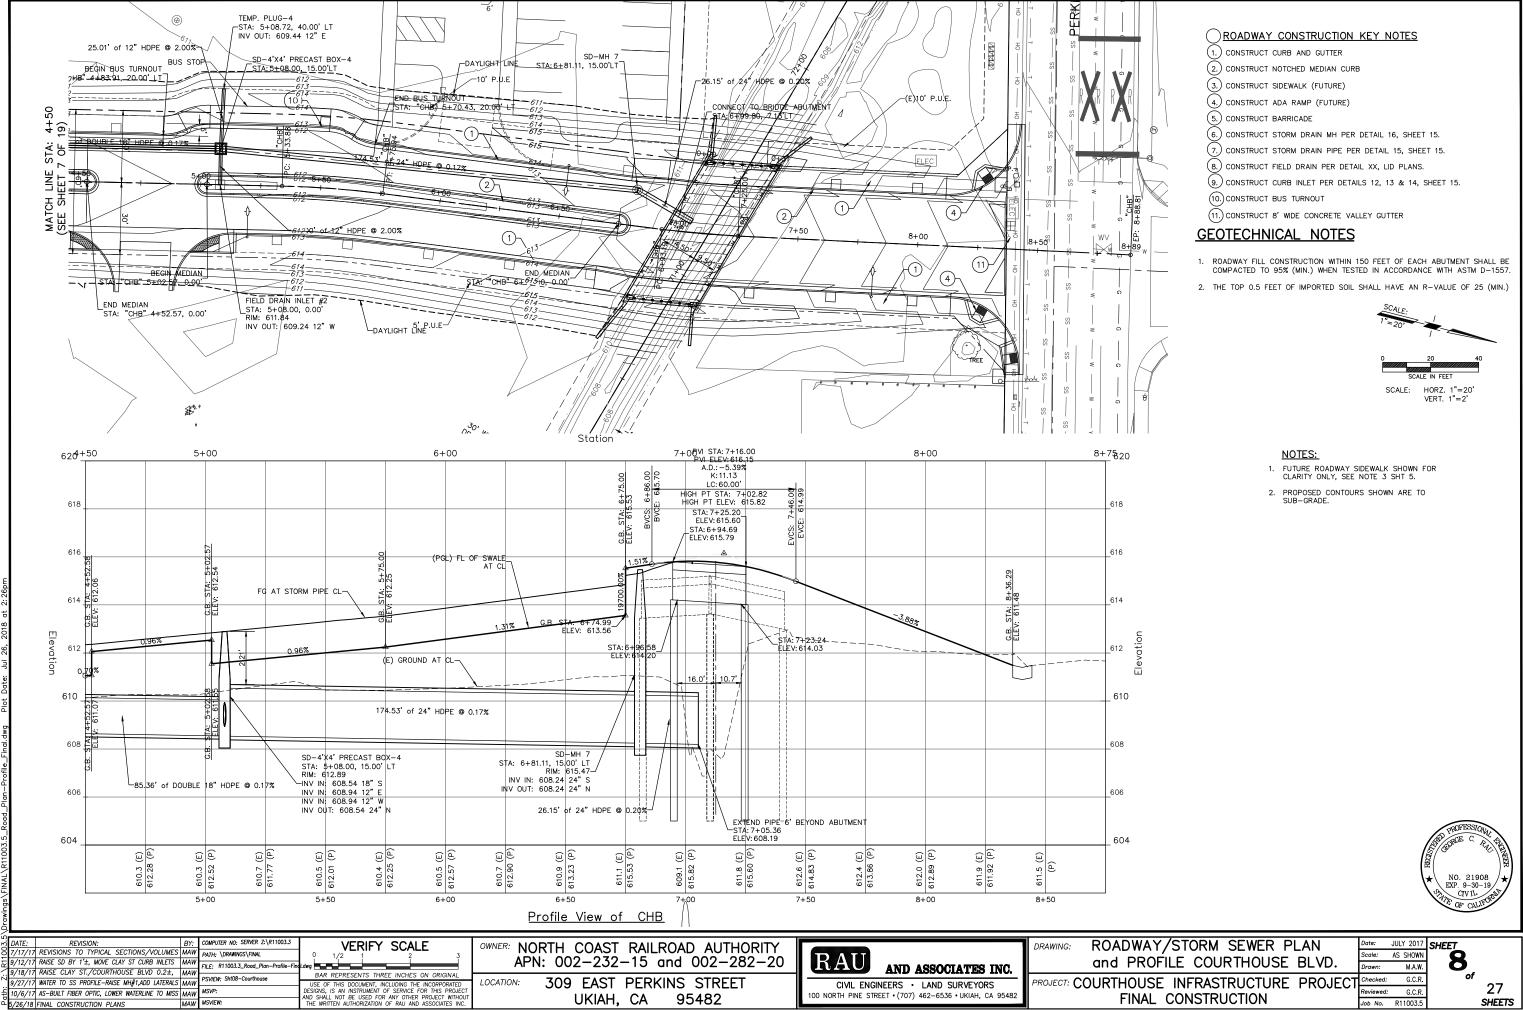

5/26/18 FINAL CONSTRUCTION PLANS

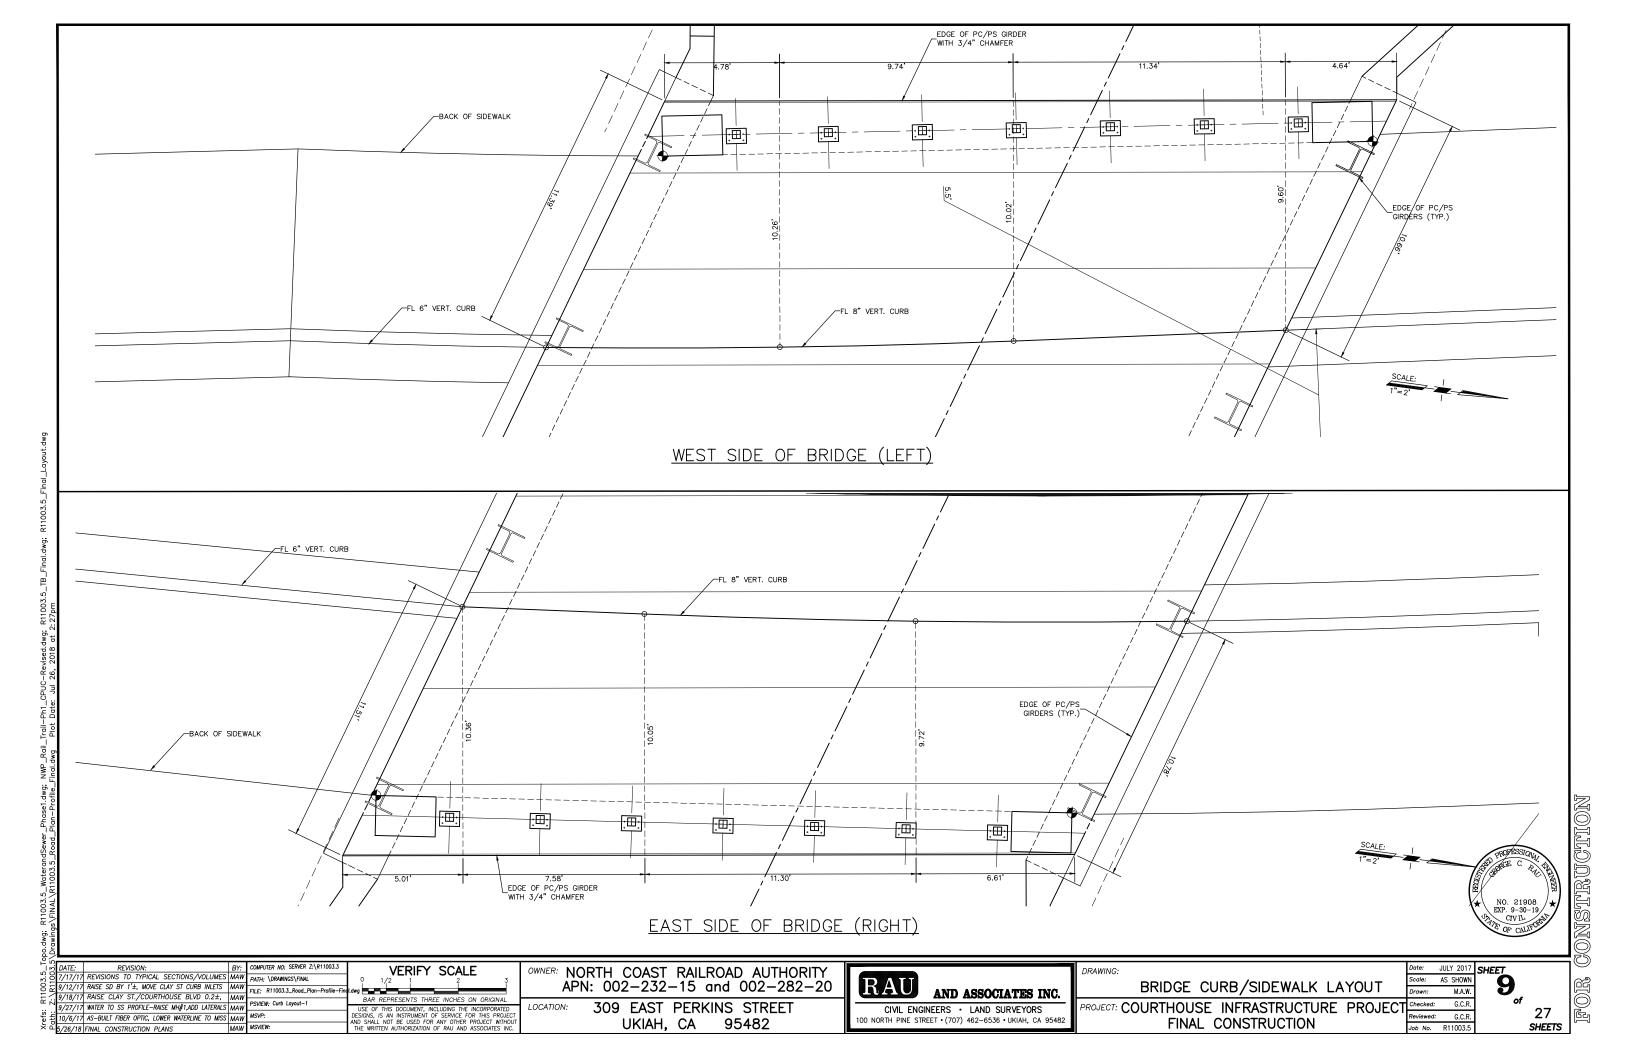

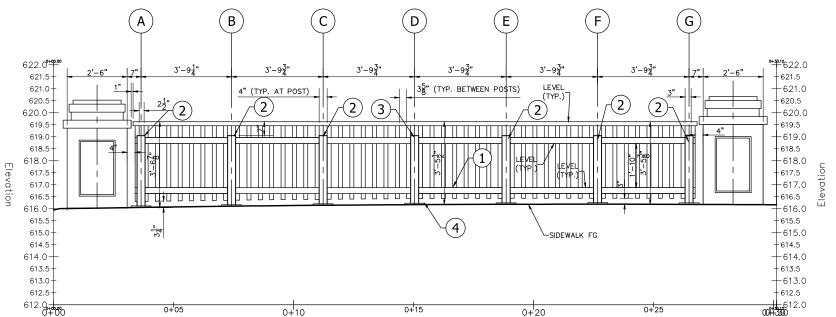

Profile View of Bridge Rail East Looking West from Creek Side

95482

Station

- 1. MINIMUM HANDRAIL HEIGHT 3'-6" FROM SIDEWALK FG.
- 2. ALL HAND RAILS AND 3"x3" CROSS MEMBERS ARE LEVEL.
- 3. ALL POSTS ARE PLUMB, HEIGHT VARIES BASED ON SIDEWALK FG.
- 4. ALL PICKETS ARE PLUMB, LENGTHS VARIES BASE ON SIDEWALK FG, 3" MIN .- 4" MAX.
- 5. DISTANCE BETWEEN POST TYPICAL EXCEPT BETWEEN POST A & B.
- 6. SEE PLAN FOR SPACING BETWEEN PICKETS.

9	<u>~</u>								
5	3	DATE:	REVISION:						
10	8	7/17/17	REVISIONS TO TYPICAL SECTIONS/VOLUMES	MAW					
8	2	9/12/17		MAW					
71	1	9/18/17	RAISE CLAY ST./COURTHOUSE BLVD 0.2±,	MAW					
				MAW					
efs	높	10/6/17	AS-BUILT FIBER OPTIC, LOWER WATERLINE TO MISS FINAL CONSTRUCTION PLANS	MAW					
×	ď	5/26/18	FINAL CONSTRUCTION PLANS	MAW					

COMPUTER NO: SERVER Z:\R11003.3 VERIFY SCALE FILE: R11003.3\_Road\_Plan-Profile PSVIEW: Railing P&P Layout-2 USE OF THIS DOCUMENT, INCLUDING THE INCORPORATED DESIGNS, IS AN INSTRUMENT OF SERVICE FOR THIS PROJECT WITHOU SHALL NOT BE USED FOR ANY OTHER PROJECT WITHOU THE WRITTEN AUTHORIZATION OF RAU AND ASSOCIATES INC.

OWNER: NORTH COAST RAILROAD AUTHORITY APN: 002-232-15 and 002-282-20 309 EAST PERKINS STREET


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EAST SIDE BRIDGE RAILING DRAWING: LAYOUT PLAN AND PROFILE

PROJECT: COURTHOUSE INFRASTRUCTURE PROJECT FINAL CONSTRUCTION

Date: JULY 2017 SHEET Scale: AS SHOWN M.A.W. Checked: G.C.R. Reviewed: G.C.R.



# Profile View of Bridge Rail West Looking East from Road Side
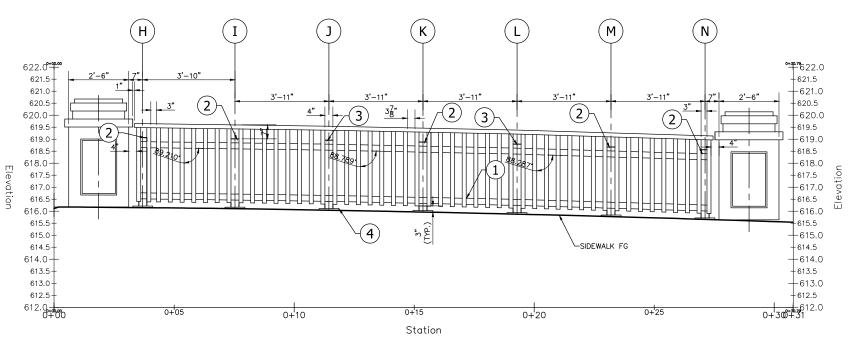
# BRIDGE RAIL KEY NOTES

- (1.) SEE RAILING DETAIL (TYPICAL) SHEET 1 OF 6 BY ROBERT VALENTINE, INC.
- (2.) SEE STANDARD POST CONNECTION DETAIL BY ROBERT VALENTINE, INC.
- (3.) SEE EXPANSION POST CONNECTION DETAIL BY ROBERT VALENTINE, INC.
- (4.) SEE BASE PLATE (TYPICAL) DETAIL SHEET 2 OF 6 BY ROBERT VALENTINE, INC.

### WEST RAILING NOTES:

- 1. MINIMUM HANDRAIL HEIGHT 3'-6" FROM SIDEWALK FG.
- 2. HAND RAILS AND 3"x3" CROSS MEMBERS ARE PARALLEL WITH SIDEWALK. DIVIDED IN 3 SECTIONS. BETWEEN H & J, J & L AND L & J. SEE PLAN FOR ANGLES.
- 3. ALL POSTS ARE PLUMB, HEIGHT VARIES BASED ON SIDEWALK FG.
- 4. ALL PICKETS ARE PLUMB, LENGTH VARIES BASE ON SIDEWALK FG, 3" MIN. 4" MAX.
- 5. DISTANCE BETWEEN POST TYPICAL EXCEPT BETWEEN POST H & I.
- 6. SEE PLAN FOR SPACING BETWEEN PICKETS.



6.0			
- 15.	DATE:	REVISION:	B,
3.5	7/17/17	REVISIONS TO TYPICAL SECTIONS/VOLUMES	M/
8 2	9/12/17		M/
= :			
- 17	9/27/17	WATER TO SS PROFILE-RAISE MH#1,ADD LATERALS	M/
Xrefs: Path:	10/6/17	AS-BUILT FIBER OPTIC, LOWER WATERLINE TO MISS	M/
× 5	5/26/18	FINAL CONSTRUCTION PLANS	MΑ

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W PSVIEW: Railing P&P Loyout-3

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W MSVP:

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OWNER: NORTH COAST RAILROAD AUTHORITY APN: 002-232-15 and 002-282-20

309 EAST PERKINS STREET UKIAH, CA 95482





DRAWING: WEST SIDE BRIDGE RAILING LAYOUT PLAN AND PROFILE


PROJECT: COURTHOUSE INFRASTRUCTURE PROJECT Checked: G.C.R. FINAL CONSTRUCTION G.C.R. Job No. R11003.5

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e:	AS SHOWN	
n:	M.A.W.	
ked:	G.C.R.	
wed:	G.C.R.	

**11** 

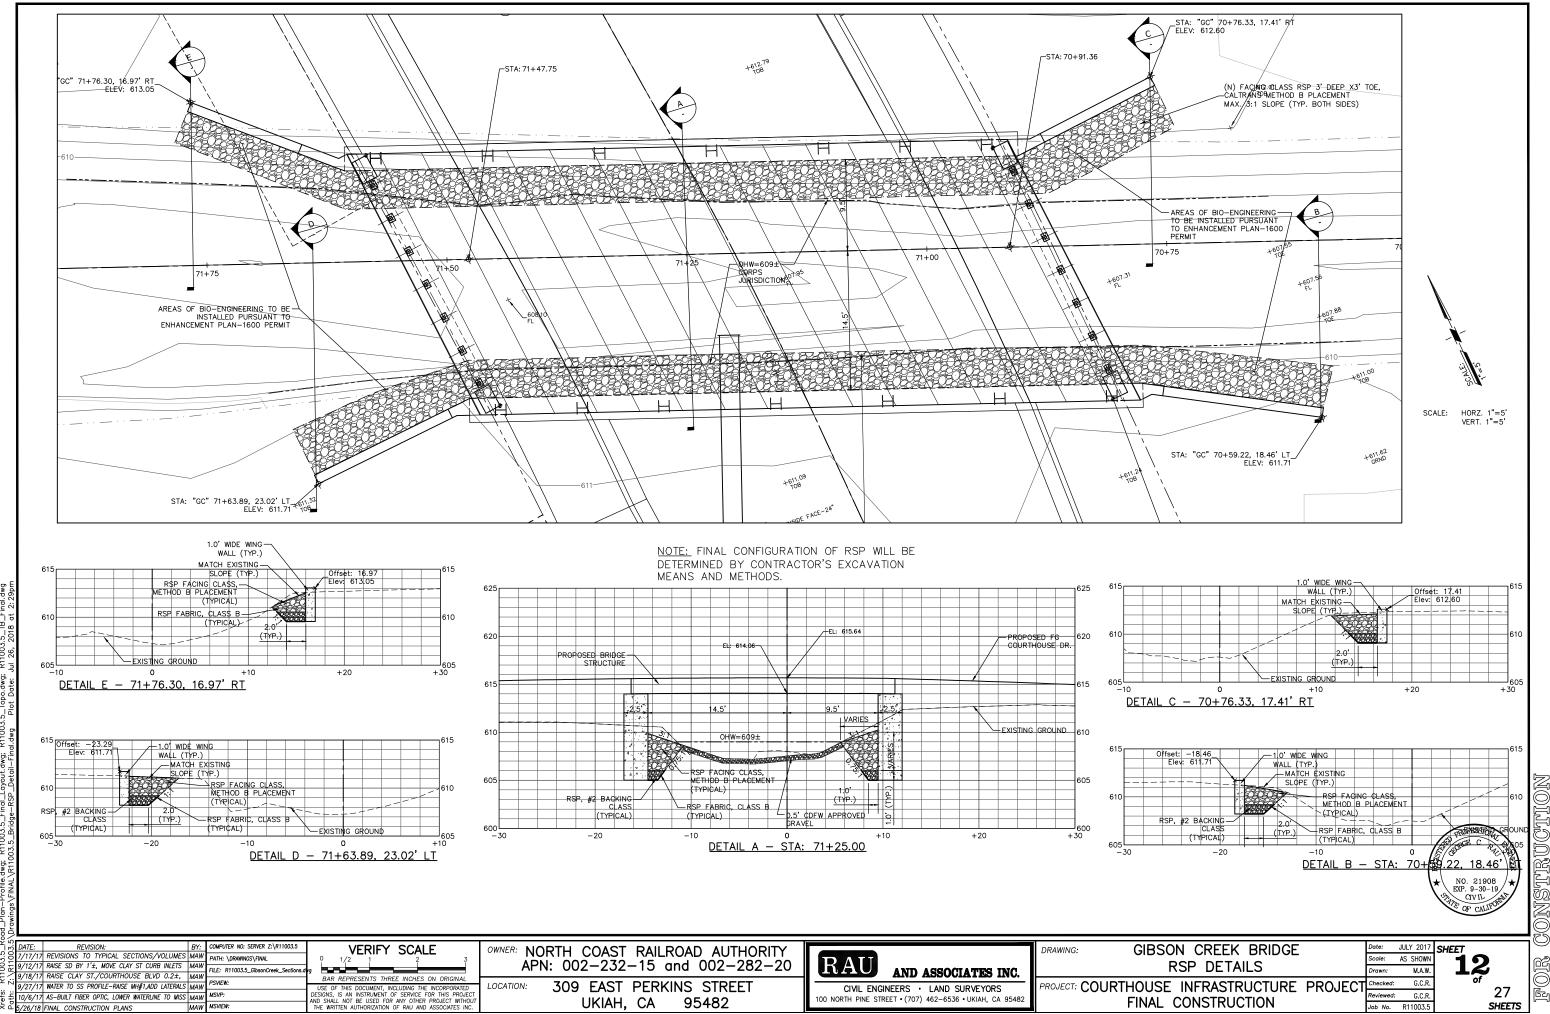

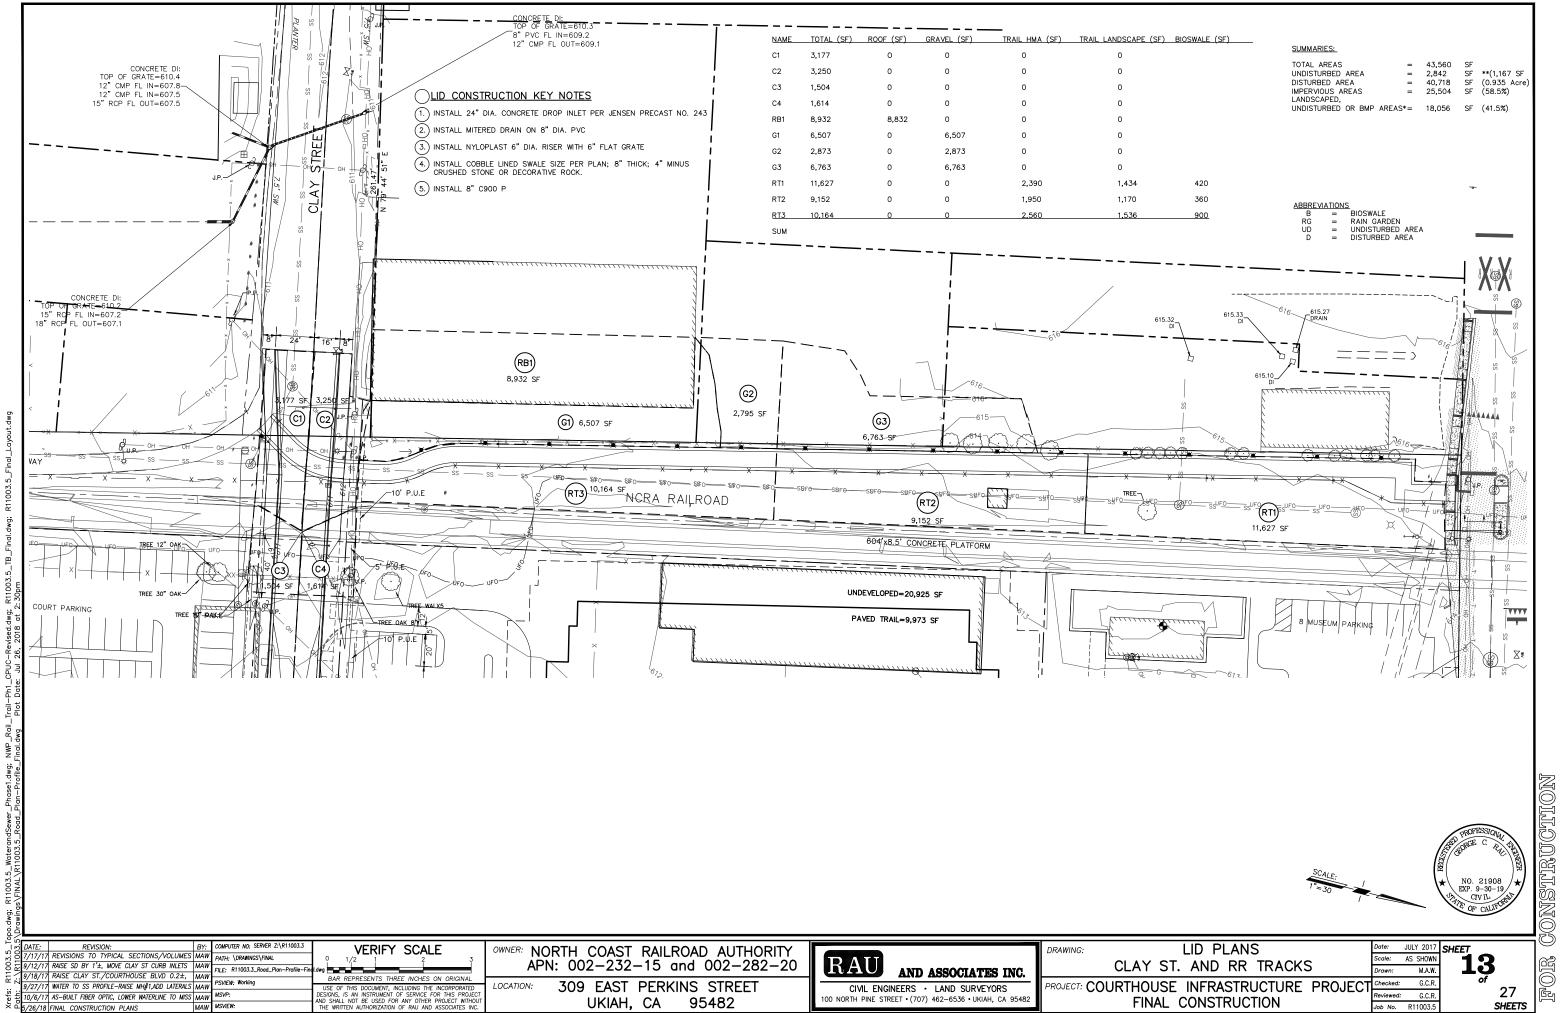

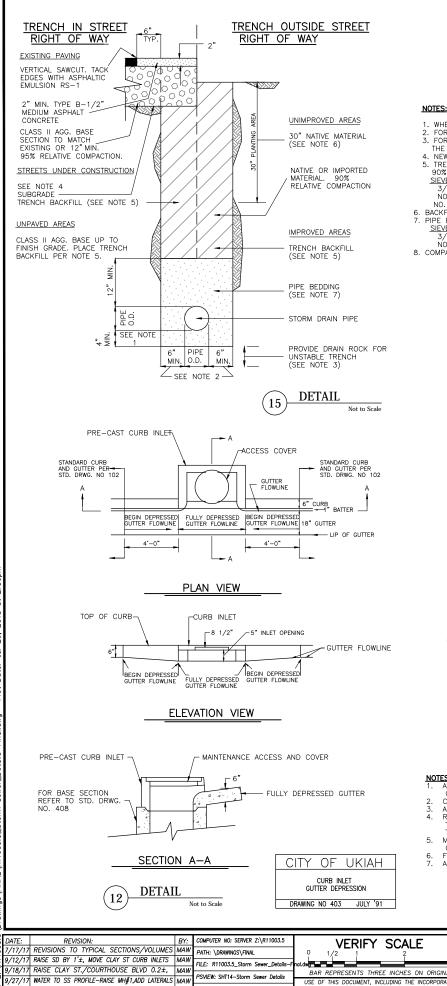

- 1. WHEN EXCAVATION IS IN ROCKY GROUND, USE THE GREATER OF 1/4 PIPE O.D. OR 4" MINIMUM.
  2. FOR 18"Ø PIPE OR LESS, USE 6" MIN., 9" MAX.; FOR GREATER THAN 18"Ø USE 9" MIN., 12" MAX.
  3. FOR UNSTABLE TRENCH PROVIDE DRAIN ROCK FOR WIDTH OF TRENCH, DEPTH AS SPECIFIED ON THE IMPROVEMENT PLANS OR BY THE ENGINEER.
  4. NEW STREET SECTION PER IMPROVEMENT PLANS.
- 5. TRENCH BACKFILL, 95% RELATIVE COMPACTION WITHIN 30" OF FINISH GRADE. REMAINING BACKFILL. 90% RELATIVE COMPACTION.

SIEVE SIZE 3/4" NO. 4 65% MIN.

NO. 100 15% MAX.


6. BACKFILL WITH NATIVE MATERIAL REMOVED FROM UPPER 30", 85% RELATIVE COMPACTION.


7. PIPE BEDDING, 90% RELATIVE COMPACTION.

SIEVE SIZE 3/4" NO. 4 % PASSING 95-100% 55-100%

8. COMPACTION: HAND AND MECHANICAL TAMPING IN 8" MAXIMUM LIFTS.

CITY OF UKIAH TRENCH DETAIL STORM DRAIN PIPE DRAWING NO. 420 FEB. '87

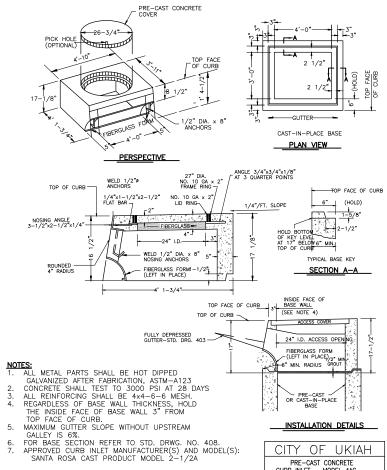


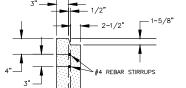

— 2" CLEAR



- OPENINGS SHALL BE CAST AS REQUIRED TO MEET CONNECTING STORM DRAIN PIPING.
- 2. DEFLECTED OPENINGS MAY BE CHIPPED IN GREEN
- 3. CONCRETE SHALL TEST 3000 P.S.I. AT 28 DAYS.
- 4. BASE SECTIONS OVER 4' IN WALL HEIGHT MAY BE CAST IN TWO PIECES.
- REFER TO STD. DRWG. NOS. 404 AND 406 FOR SETTING DETAILS.
- 6. APPROVED MANUFACTURER(S): SANTA ROSA CAST PRODUCTS CO.

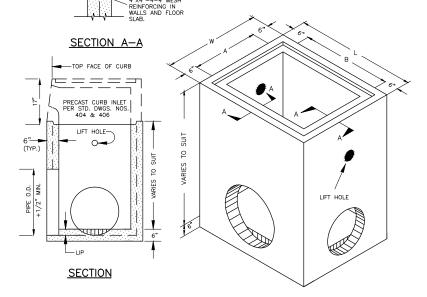

PRECAST CURB	BASE SECTION DIMENSIONS				WEIGHT OF BASE COMPONENTS			
INLET MODEL	Α	В	w	L	WALL PER VERT. FT.	6" FLOOR SLAB	CURB INLET AND COVER	
MODEL 2-1/2A	2'-0"	2'-6"	3'-0"	3'-6"	825 LB.	375 LB.	700 LB.	
MODEL 4AC	3'-0"	4'-0"	4'-0"	5"-0"	1200 LB.	900 LB.	1500 LB.	

DETAIL (14)

CITY OF UKIAH PRECAST BASE SECTION FOR CURB INLET DRAWING NO. 408 MAR. '87



10/6/17 AS-BUILT FIBER OPTIC, LOWER WATERLINE TO MISS MAW

5/26/18 FINAL CONSTRUCTION PLANS

USE OF THIS DOCUMENT, INCLUDING THE INCORPORATED DESIGNS, IS AN INSTRUMENT OF SERVICE FOR THIS PROJECT AND SHALL NOT BE USED FOR ANY OTHER PROJECT WITHOUT THE WRITTEN AUTHORIZATION OF RAU AND ASSOCIATES INC

OWNER: NORTH COAST RAILROAD AUTHORITY APN: 002-232-15 and 002-282-20

Not to Scale

CITY OF UKIAH

DRAWING NO. 406 JUL '91

PRE-CAST CONCRETE CURB INLET - MODEL 4AC DETAILS

309 EAST PERKINS STREET UKIAH, CA 95482




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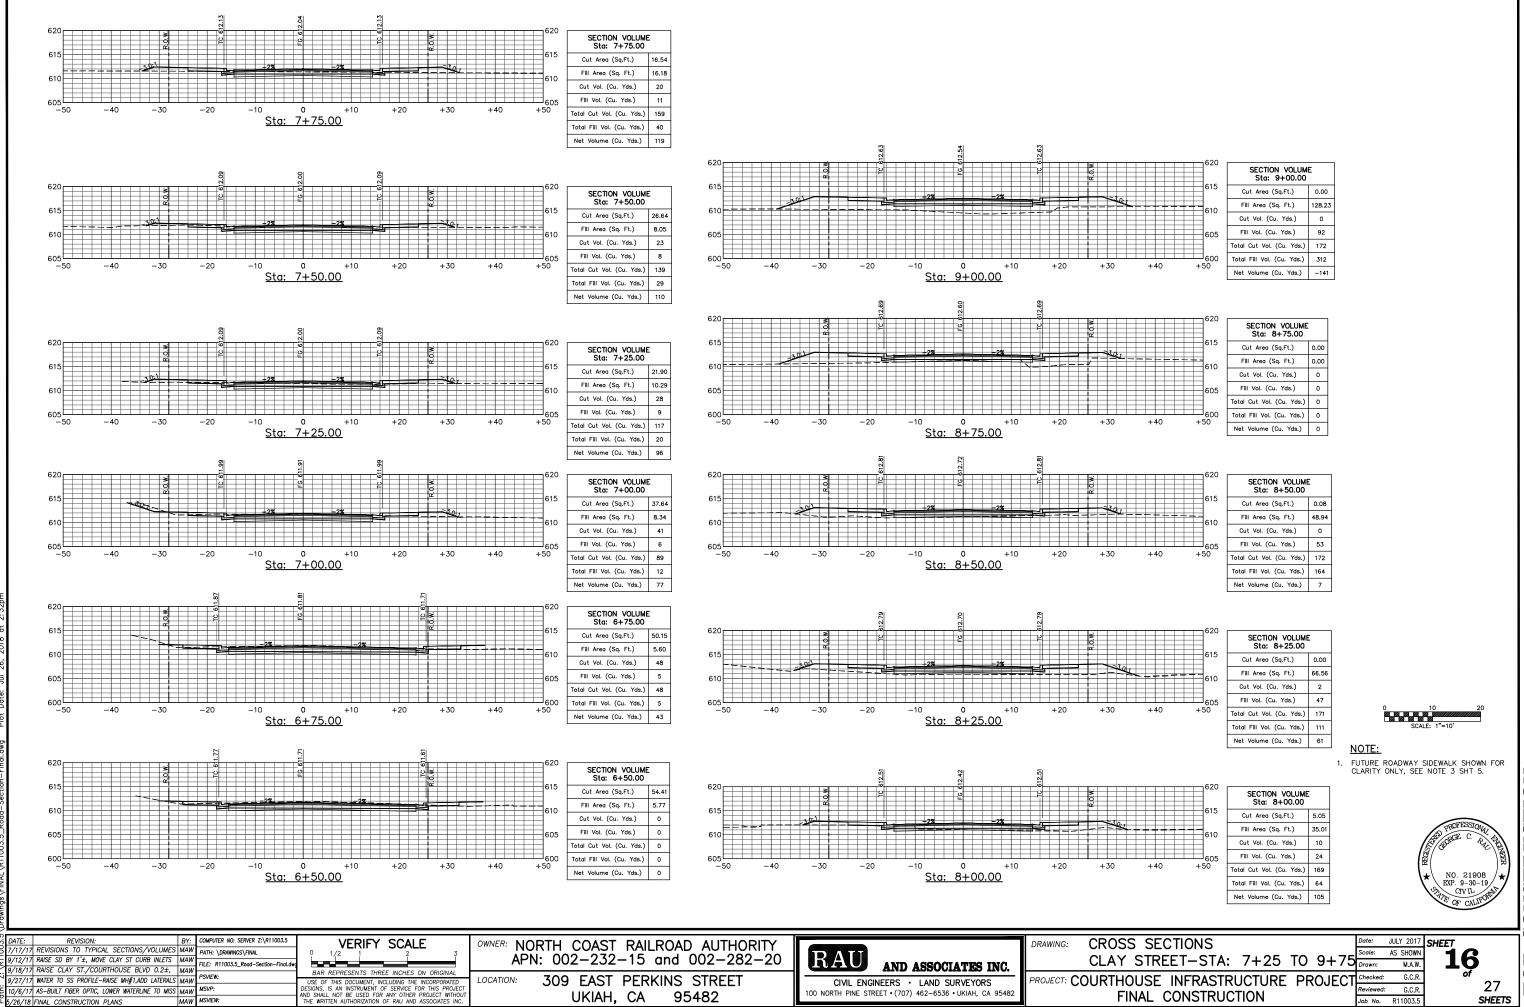
STORM SEWER DETAILS DRAWING:

		Draw
POJECT: COURTHOUSE INFRASTRUCTURE PROJE	-CT	Chec
TIME CONCEDITION	_01	Revie
FINAL CONSTRUCTION		

JULY 2017 SHEET AS SHOWN M.A.W ecked: G.C.R. iewed: G.C.R.

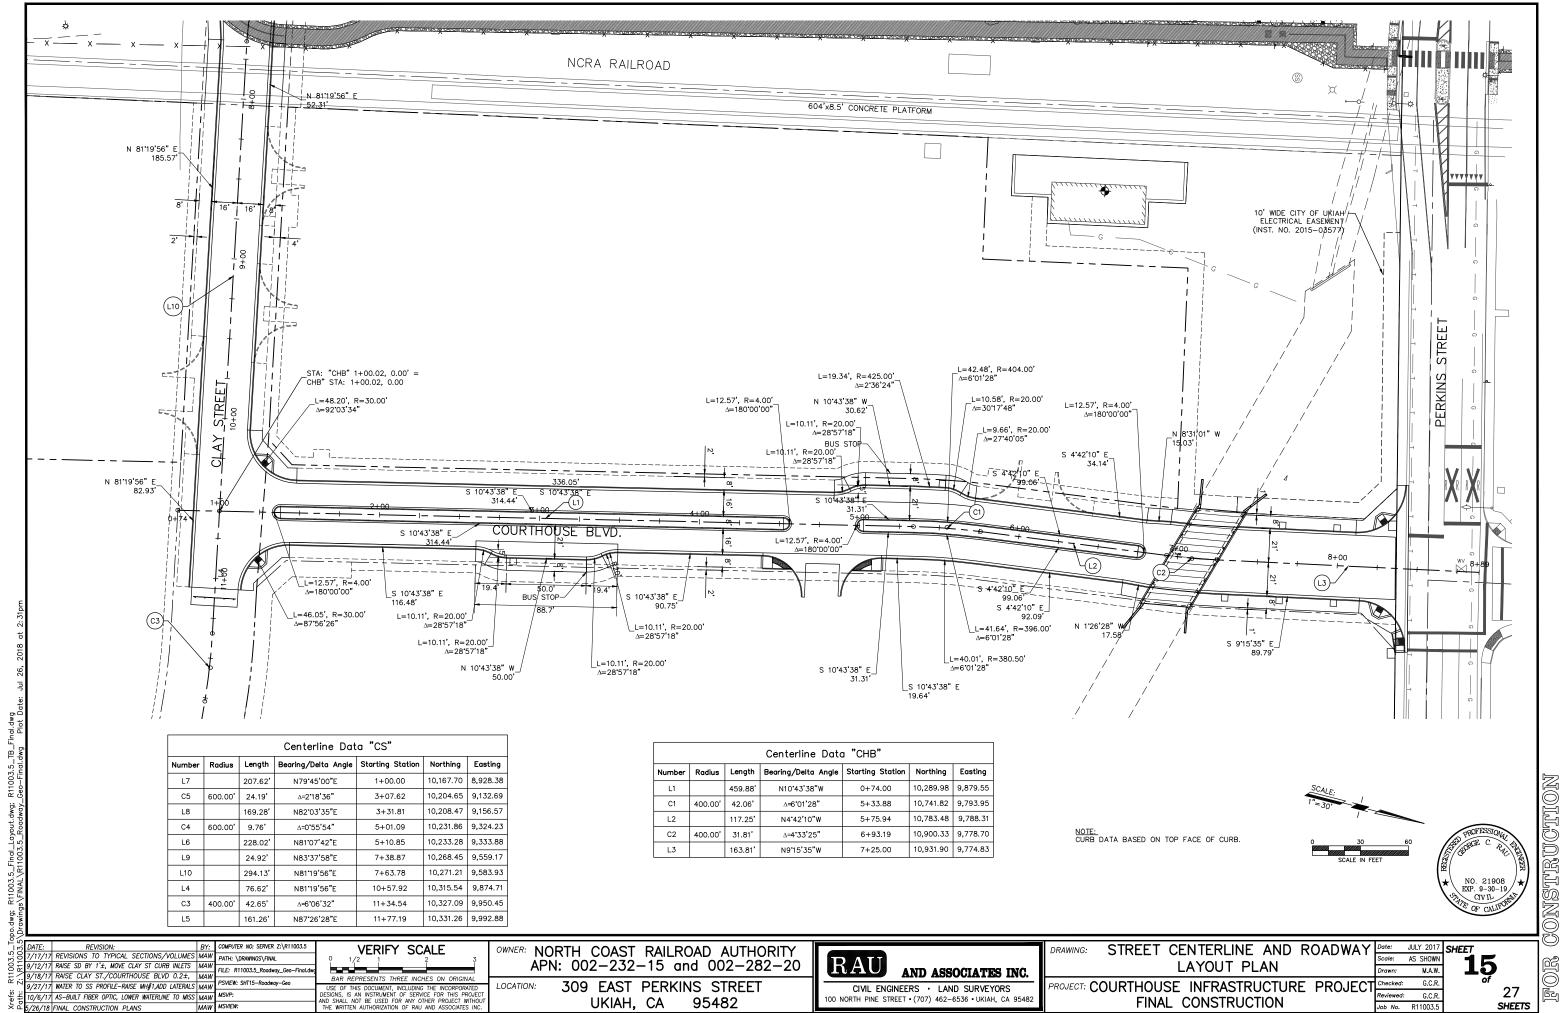

/26/18 FINAL CONSTRUCTION PLANS




95482

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0/6/17 AS-BUILT FIBER OPTIC, LOWER WATERLINE TO MISS MAN

SHEETS

Reviewed: G.C.R.

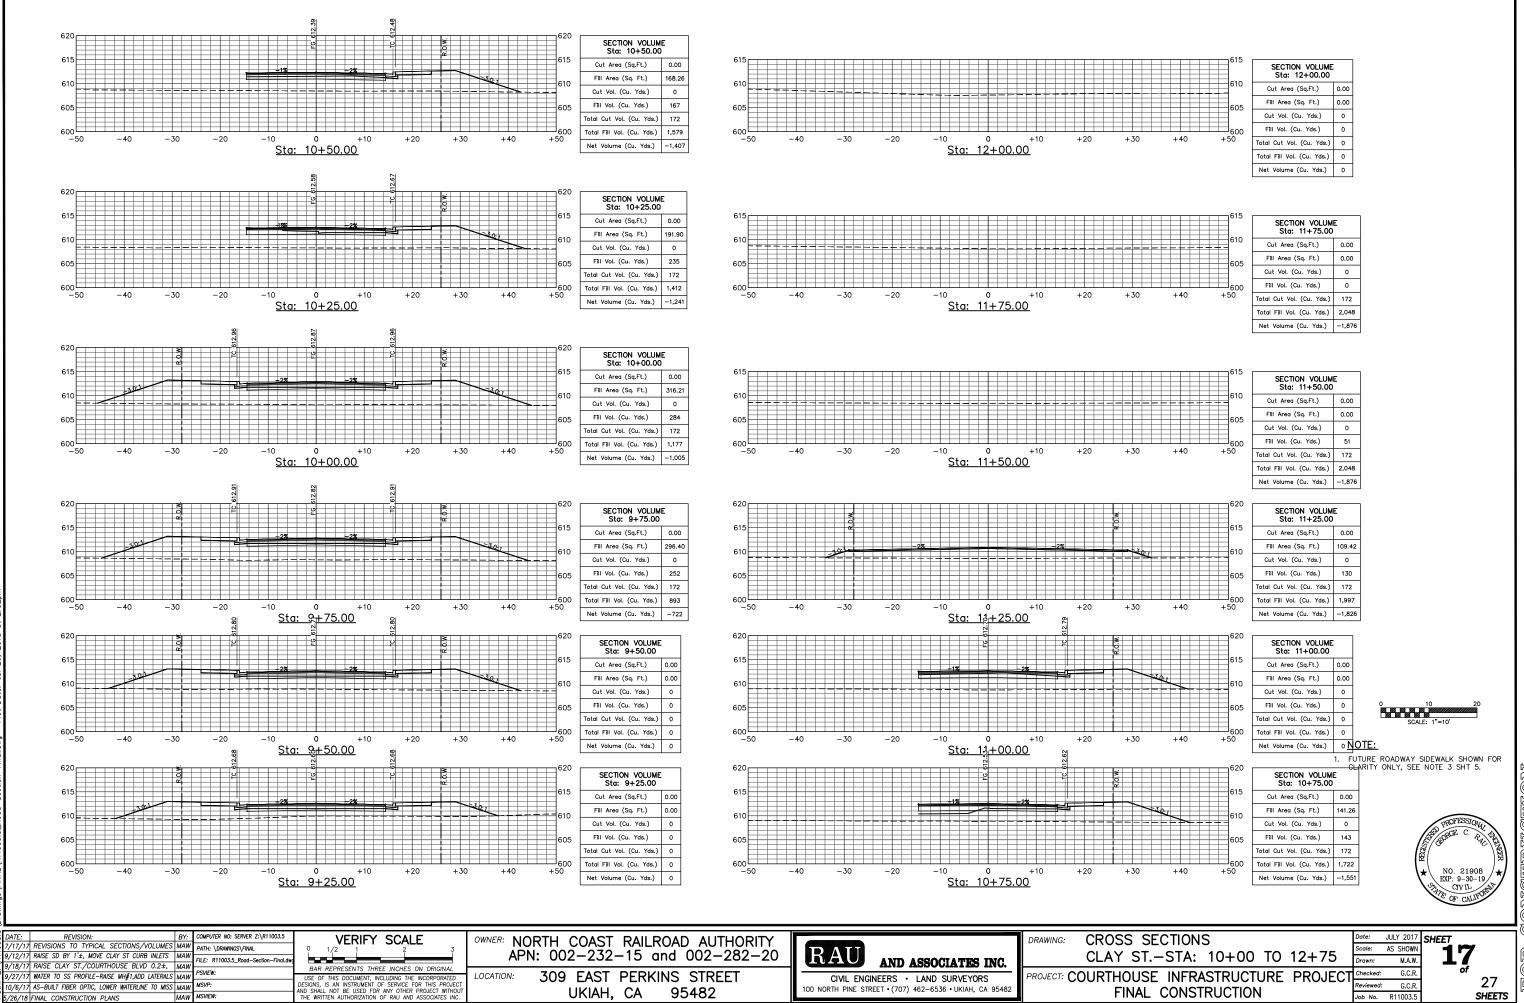


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0/6/17 AS-BUILT FIBER OPTIC, LOWER WATERLINE TO MISS MAW

SHEETS

Reviewed: G.C.R.

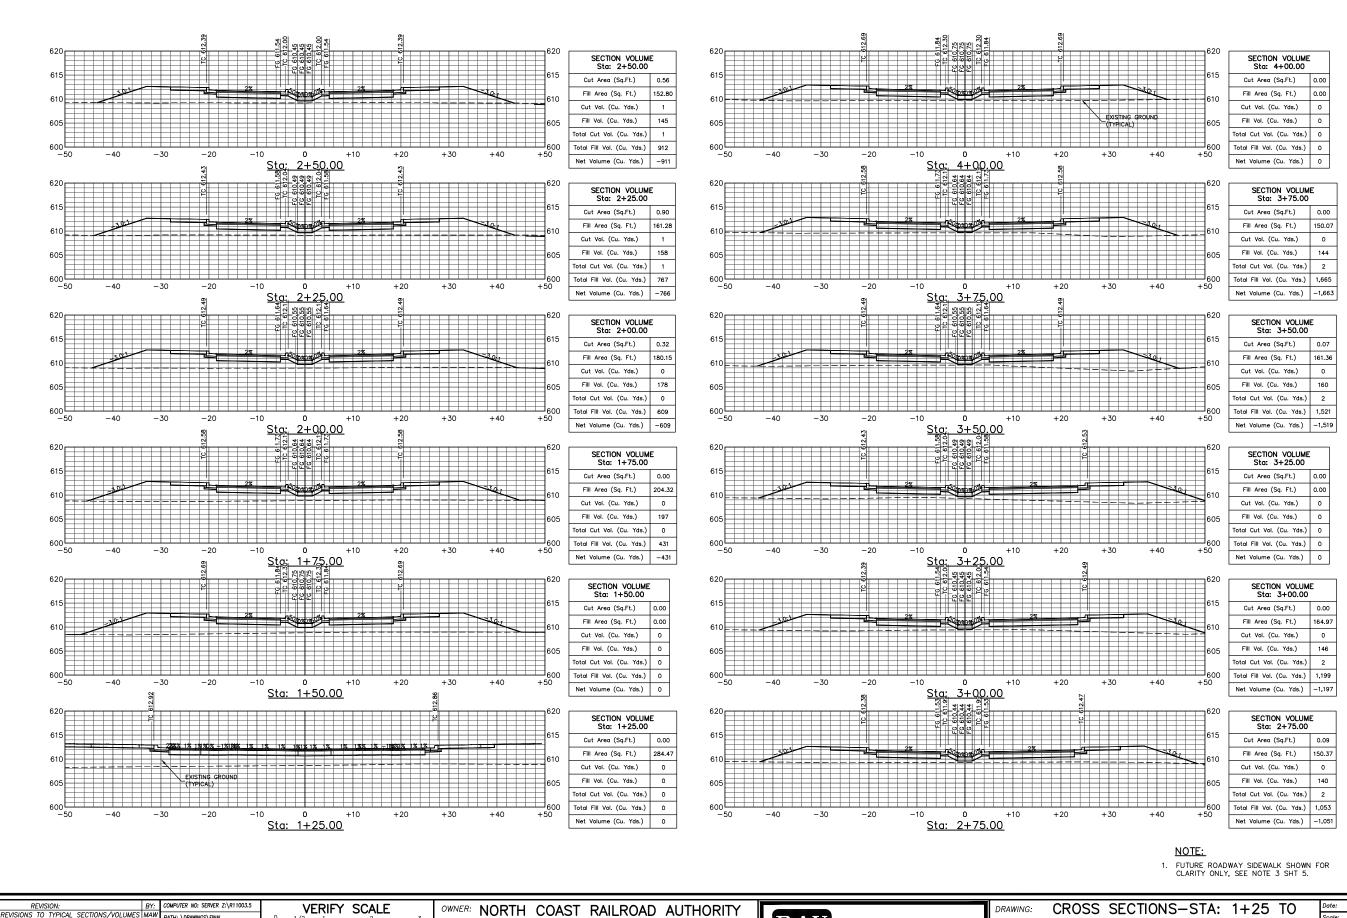

APN: 002-232-15 and 002-282-20

309 EAST PERKINS STREET

95482

UKIAH, CA

PATH: \DRAWINGS\FINAL

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RAISE SD BY 1'±, MOVE CLAY ST CURB INLETS MAW

/18/17 RAISE CLAY ST./COURTHOUSE BLVD 0.2±, MAN

0/6/17 AS-BUILT FIBER OPTIC, LOWER WATERLINE TO MISS MAN

27/17 WATER TO SS PROFILE-RAISE MH#1,ADD LATERALS MAW

JULY 2017 SHEET AS SHOWN

3+75 - COURTHOUSE BLVD. PROJECT: COURTHOUSE INFRASTRUCTURE PROJECT


FINAL CONSTRUCTION

AND ASSOCIATES INC.

CIVIL ENGINEERS + LAND SURVEYORS


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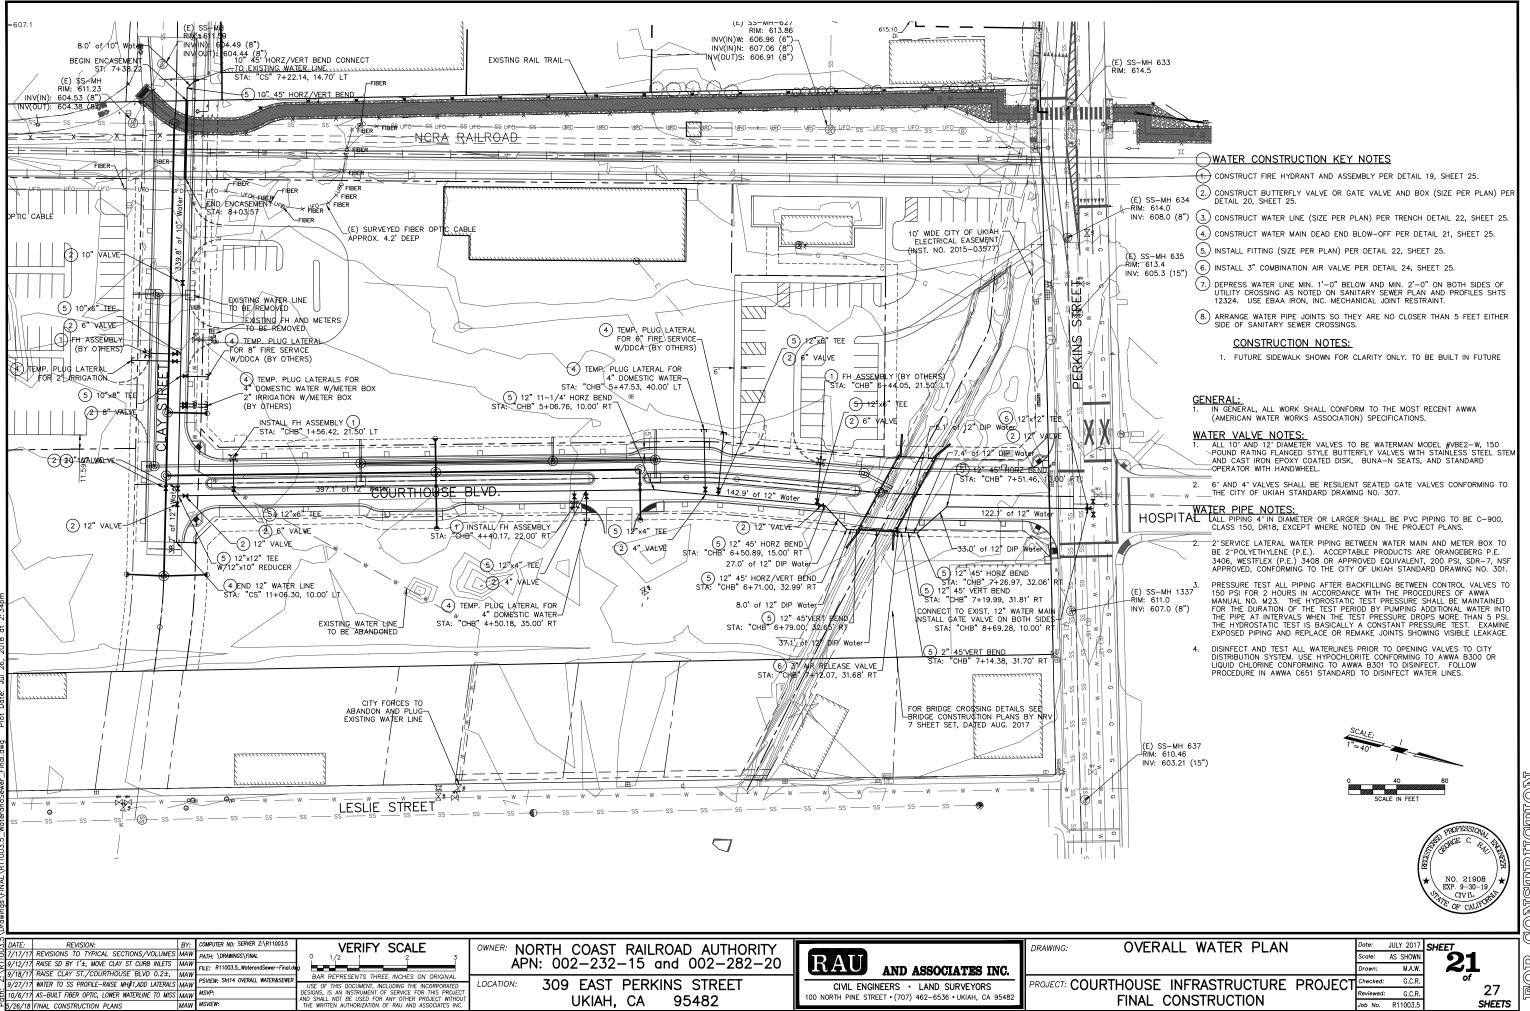
Reviewed: G.C.R.

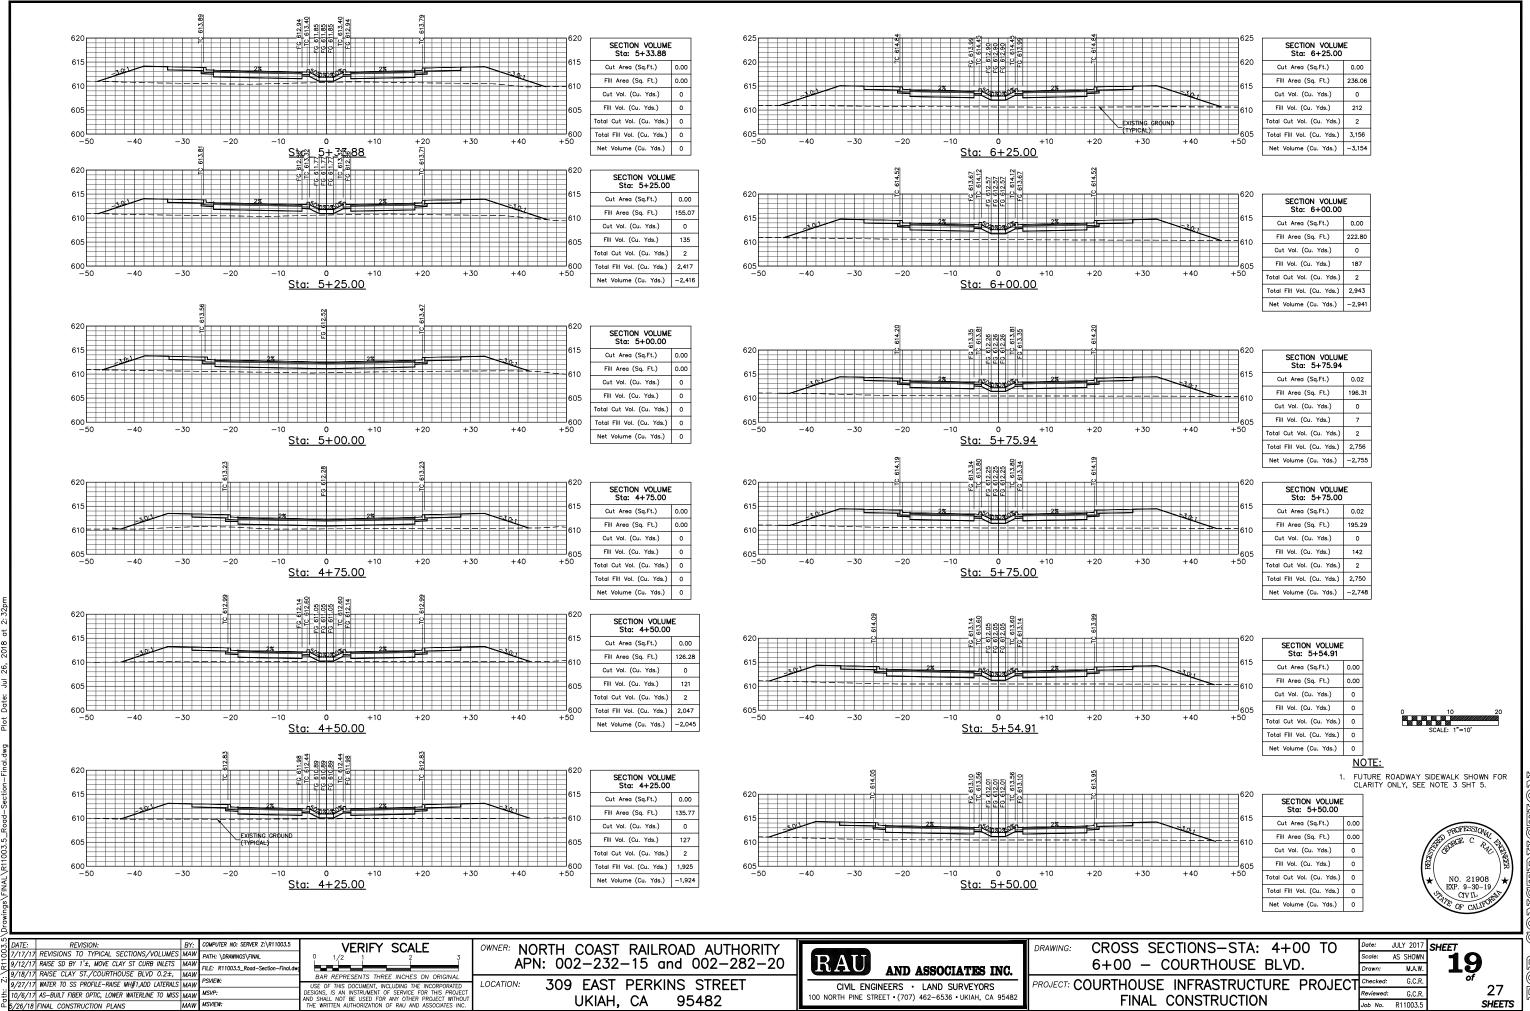


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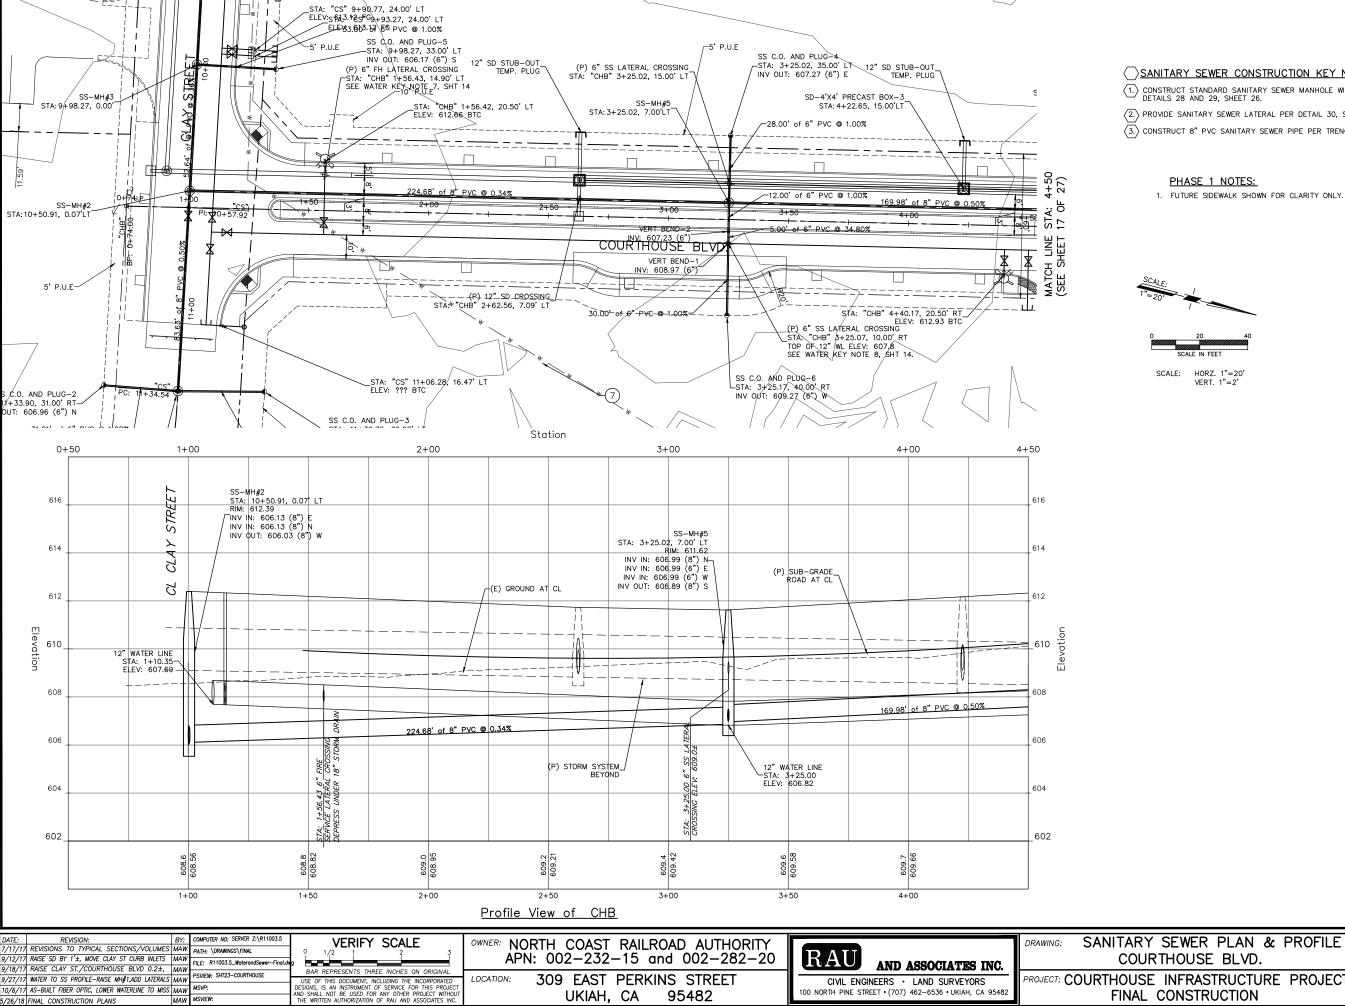
SHEETS





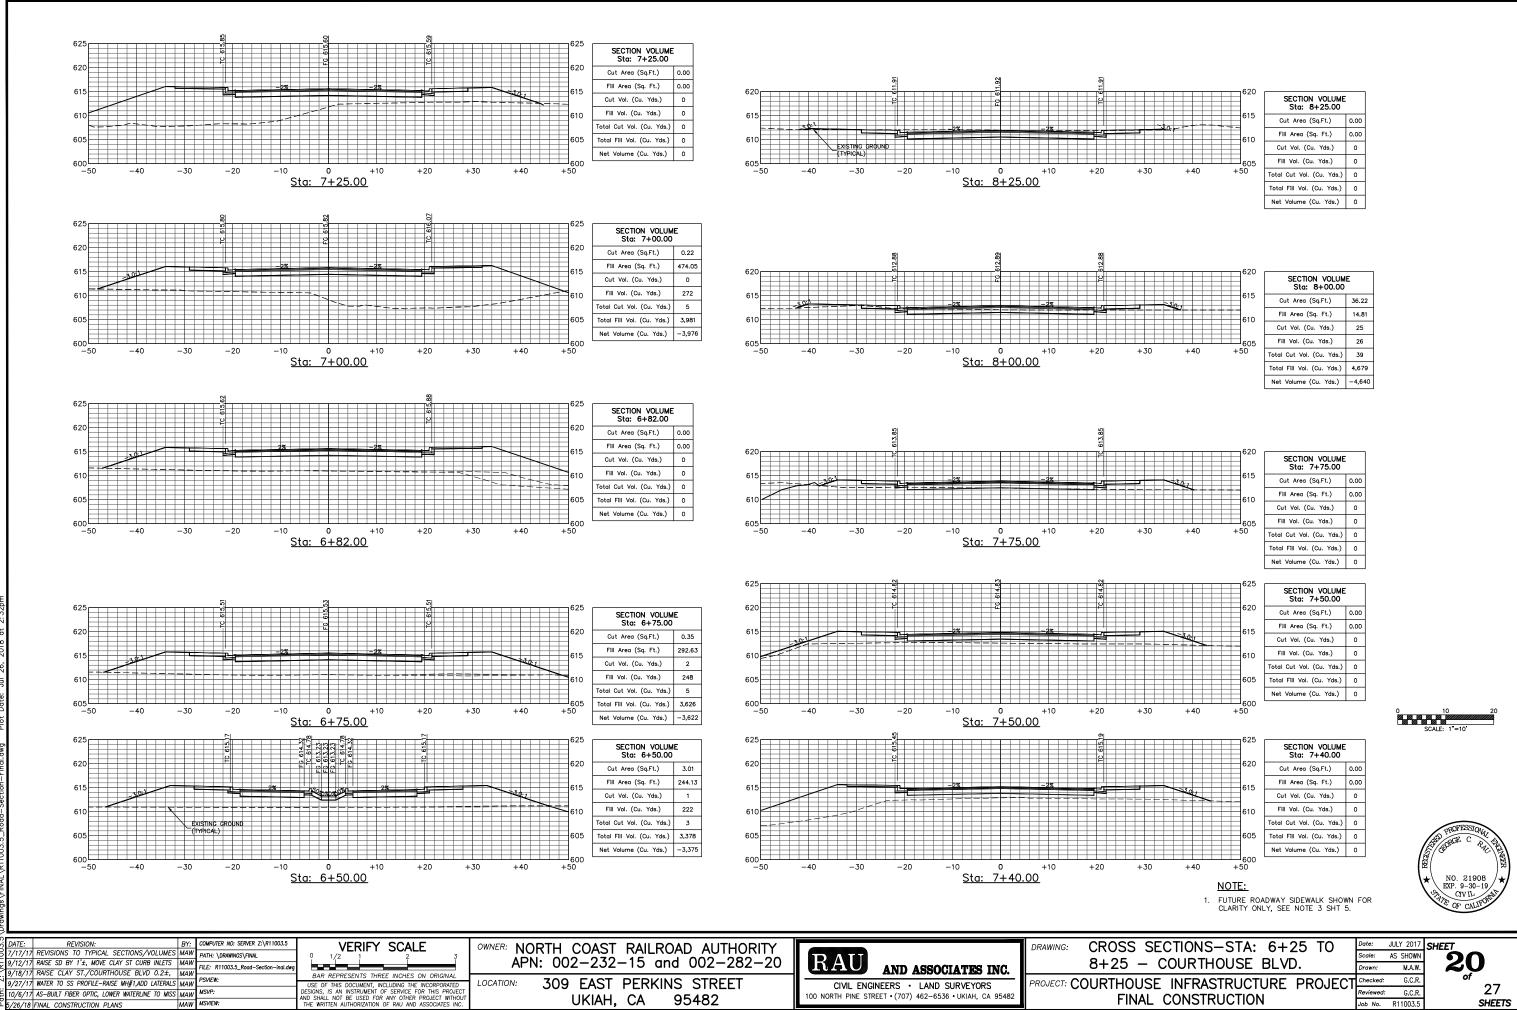

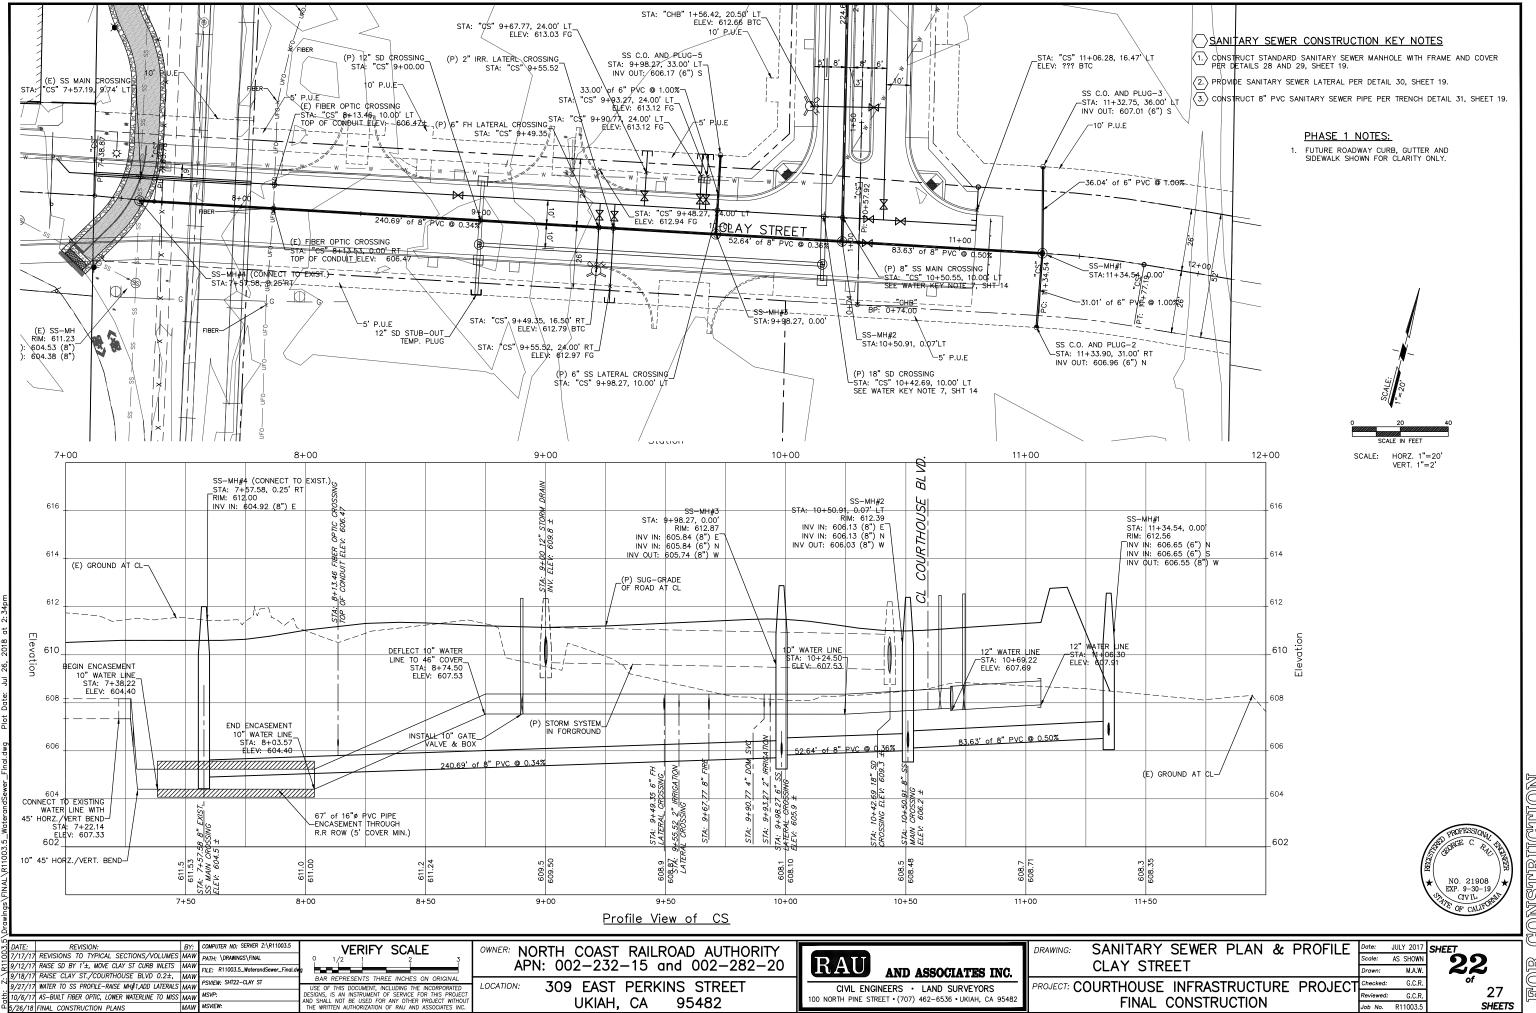26/18 FINAL CONSTRUCTION PLANS



95482

0/6/17 AS-BUILT FIBER OPTIC, LOWER WATERLINE TO MISS MAN

26/18 FINAL CONSTRUCTION PLANS

SANITARY SEWER CONSTRUCTION KEY NOTES

 $\overbrace{\text{1.}\rangle}$  Construct standard sanitary sewer manhole with frame and cover per details 28 and 29, sheet 26.

 $\overline{\langle 2. \rangle}$  PROVIDE SANITARY SEWER LATERAL PER DETAIL 30, SHEET 26


(3.) CONSTRUCT 8" PVC SANITARY SEWER PIPE PER TRENCH DETAIL 31, SHEET 26.

1. FUTURE SIDEWALK SHOWN FOR CLARITY ONLY.


PROJECT: COURTHOUSE INFRASTRUCTURE PROJECT FINAL CONSTRUCTION

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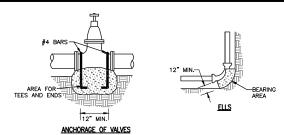
Date: JULY 2017 SHEET cale: AS SHOWN M.A.W G.C.R. Reviewed: G.C.R.

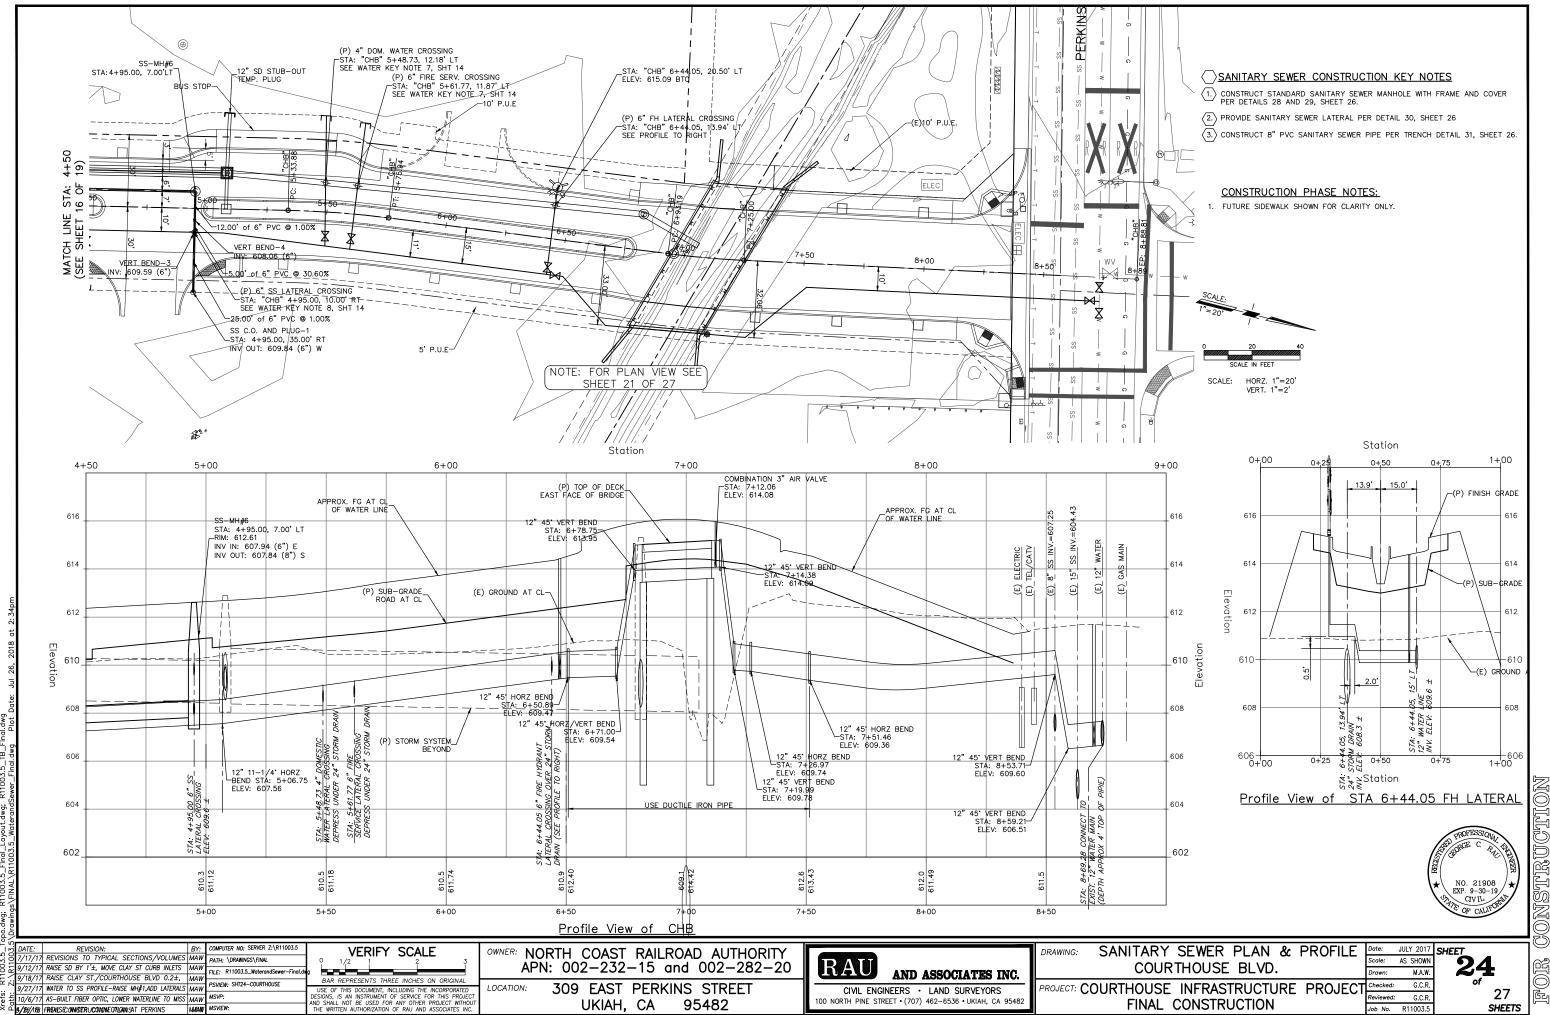

\* For bends less than 11 1/4 , use thrust areas for 11 1/4 , unless otherwise approved by the engineer.

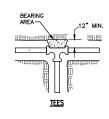

TRENCH WALL



2. FOR 18"0 PIPE OR LESS, USE 6" MIN., 9" MAX.; FOR GREATER THAN 18"0 USE 9" MIN., 12" MAX.

1. WHEN EXCAVATION IS IN ROCKY GROUND, USE THE GREATER OF 1/4

3. FOR UNSTABLE TRENCH PROVIDE DRAIN ROCK FOR WIDTH OF TRENCH, DEPTH AS SPECIFIED ON THE IMPROVEMENT PLANS OR BY THE ENGINEER.

4. NEW STREET SECTION PER IMPROVEMENT PLANS.


5. TRENCH BACKFILL, 95% RELATIVE COMPACTION WITHIN 30" OF FINISH GRADE. REMAINING BACKFILL, 90% RELATIVE COMPACTION.

SIEVE SIZE 3/4" NO. 4 % PASSING 90-100 30-65 NO. 200

6. BACKFILL WITH NATIVE MATERIAL REMOVED FROM UPPER 30", 85% RELATIVE COMPACTION.

7. PIPE BEDDING, 90% RELATIVE COMPACTION.

8. COMPACTION: HAND AND MECHANICAL TAMPING IN 8" MAXIMUM LIFTS. NO JETTING PERMITTED

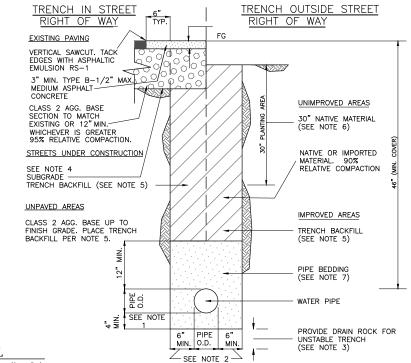

CITY OF UKIAH

TRENCH DETAIL

WATER LINE

DRAWING NO. 320 FEB. '87

**OUTLET** 

SHUT OFF VALVE

PIPE RISER-





- THRUST BLOCKING TABLE CALCULATED FOR SOIL BEARING CAPACITY OF 1,000 LBS./SQ. FT. AND 175 LBS./SQ. IN. TEST PRESSURE.
   ANY GREATER SOIL BEARING CAPACITY THAN 1,000 LBS./SQ. IN., SHALL BE DETERMINED BY AN ENGINEER, AND APPROVED BY THE CITY.
- CONCRETE BLOCKING SHALL BE CLASS B CONCRETE 2,000 LBS./SQ. IN..
  CONCRETE BLOCKING, CAST IN PLACE, TO EXTEND FROM BELLS OF FITTINGS TO UNDISTURBED GROUNDS.
- 5. FOR PLUGGED LEG(S) OF TEE OR CROSS WITH 90 FLOW PATTERN, USE DATA LISTED FOR 90 BFND.










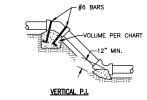

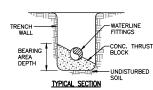

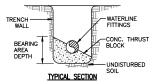

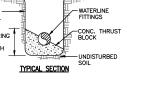

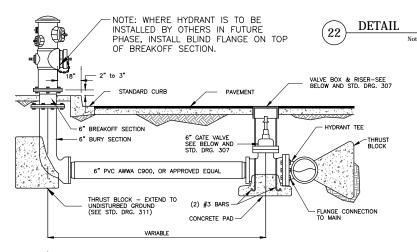


AREAS REQUIRED


DRAWING NO. 311 JUL '91

AMERICAN DARLING CRS OR APPROVED EQUAL. REFER TO STD. DRG. 307 FOR CONSTRUCTION DETAILS. GATE VALVE:

CHRISTY G5, OR APPROVED EQUAL.

FIRE HYDRANT: SPECIFY TWO (2) 2-1/2" HOSE OUTLETS AND ONE (1) 4-1/2" STEAMER OUTLET WHEN ORDERING. USE THE FOLLOWING TYPES: JONES J-3760, RICH NO.76 OR EQUALS SPECIFICALLY APPROVED.

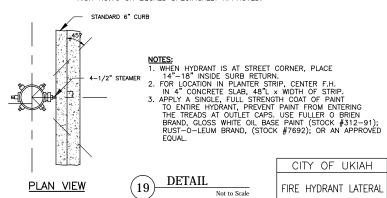

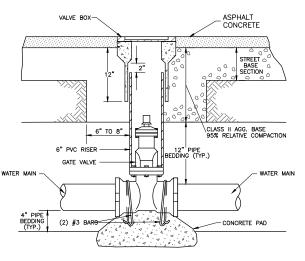

#### **NOTES:**


- 1. GATE VALVES SHALL BE OF THE TYPE RESILIENT SEAT WITH MODIFIED WEDGE, AND SHALL MEET AWWA 509—87 STANDARD. USE AMERICAN DARLING CRS OR APPROVED EQUIVALENT.

  2. VALVE BOXES SHALL BE SET FLUSH WITH FINISH STREET GRADE. BOX COVER SHALL INDICATE "WATER" ON TOP. VALVE BOXES SHALL BE CHRISTY G-5 OR APPROVED EQUIVALENT.

  3. VALVE CONNECTIONS SHALL BE PUSH—ON WHEN USING AWWA C900 PVC PIPE. CONNECTIONS SHALL BE MECHANICAL JOINT FOR PIPE OTHER THAN PVC.





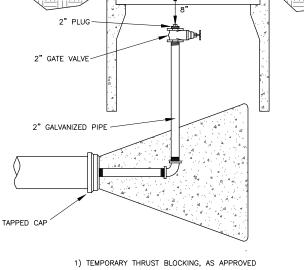

CHRISTY BOX B-9 W/METAL LID

IN ROADWAY

BY THE CITY, SHALL BE ALLOWED ON TEMPORARY

2) PERMANENT DEAD-ENDS SHALL BE CONCRETE THRUST BLOCKED.

DRAWING

DETAIL

CITY OF UKIAH WATER MAIN DEADEND BLOW-OFF DRAWING NO. 309 FEB. '86



SINGLE BODY COMBINATION 3" AIR VALVE DETAIL

ATE: REVISION: BY: /17/17 REVISIONS TO TYPICAL SECTIONS/VOLUMES MAW 12/17 RAISE SD BY 1'±, MOVE CLAY ST CURB INLETS MAW 9/18/17 RAISE CLAY ST./COURTHOUSE BLVD 0.2±, MAW /27/17 WATER TO SS PROFILE-RAISE MH#1,ADD LATERALS MAW 10/6/17 AS-BUILT FIBER OPTIC, LOWER WATERLINE TO MISS MAW

5/26/18 FINAL CONSTRUCTION PLANS

BY: COMPUTER NO: SERVER Z:\R11003.5 PATH: \DRAWINGS\FINAL FILE: R11003.5 Water-Details-Final PSVIEW: SHT25-Water Details

VERIFY SCALE USE OF THIS DOCUMENT, INCLUDING THE INCORPORATED DESIGNS, IS AN INSTRUMENT OF SERVICE FOR THIS PROJECT AND SHALL NOT BE USED FOR ANY OTHER PROJECT WITHOU THE WRITTEN AUTHORIZATION OF RAU AND ASSOCIATES INC

DRAWING NO. 305 NOV. '87

OWNER: NORTH COAST RAILROAD AUTHORITY APN: 002-232-15 and 002-282-20

> 309 EAST PERKINS STREET UKIAH, CA 95482



PROJECT: COURTHOUSE INFRASTRUCTURE PROJECT FINAL CONSTRUCTION

WATER DETAILS

JULY 2017 SHEET Scale: AS SHOWN M.A.V G.C.R. Reviewed: G.C.R


SHEETS


SINGLE BODY COMBINATION

AIR VALVE

VAL-MATIC MODEL 203C.2

12" DIP ABOVE GROUND WATER PIPE

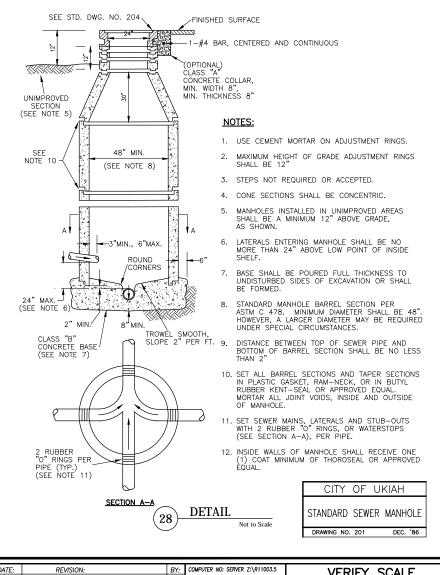

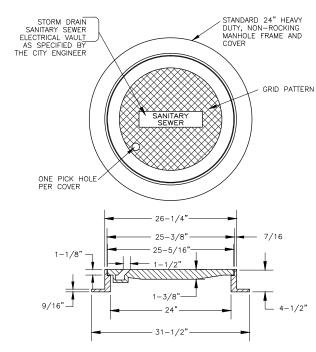


- SPECIFY "STORM DRAIN", "SANITARY SEWER", OR "ELECTRICAL VAULT" WHEN ORDERING; ALL CASTINGS SHALL BE DIPPED IN ASPHALT PAINT (BLACK BITUMINOUS PAINT).
- 2. ALL MATERIAL USED IN MANUFACTURING SHALL CONFORM TO A.S.T.M. A-159-G3000 OR TO UNITED STATES GOVERNMENT SPECIFICATIONS QQ1-652b.
- 3. MINIMUM WEIGHT REQUIREMENTS: COVER--130 POUNDS FRAME--135 POUNDS

4. APPROVED MANHOLES AND COVER ASSEMBLAGES: PHOENIX IRON WORKS P-1090 PINKERTON FOUNDRY A-640 SOUTH BAY FOUNDRY A-46 valley iron and steel 12

29

DETAIL

CITY OF UKIAH MANHOLE FRAME & COVER DRAWING NO. 204

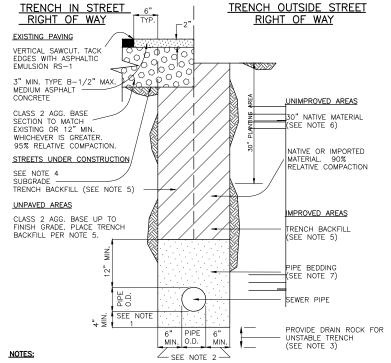

1. WHEN EXCAVATION IS IN ROCKY GROUND, USE THE GREATER OF 1/4 PIPE O.D. OR 4" MINIMUM. 2. FOR 18"0 PIPE OR LESS, USE 6" MIN., 9" MAX.; FOR GREATER THAN 18"0 USE 9" MIN., 12" MAX. 3. FOR UNSTABLE TRENCH PROVIDE DRAIN ROCK FOR WIDTH OF TRENCH, DEPTH AS SPECIFIED ON THE IMPROVEMENT PLANS OR BY THE ENGINEER.

NEW STREET SECTION PER IMPROVEMENT PLANS.

TRENCH BACKFILL, 95% RELATIVE COMPACTION WITHIN 30" OF FINISH GRADE. REMAINING BACKFILL, 90% RELATIVE COMPACTION.

SIEVE SIZE 3/4" NO. 4 95 65 MIN


NO. 200
15 MAX
BACKFILL WITH NATIVE MATERIAL REMOVED FROM UPPER 30", 85% RELATIVE COMPACTION.
PIPE BEDDING, 90% RELATIVE COMPACTION.

SIEVE SIZE 3/4" NO.4 % PASSING 95-100 55-100

8. COMPACTION: HAND AND MECHANICAL TAMPING IN 8" MAXIMUM LIFTS.

NO JETTING PERMITTED FILE: UKIAH\DWG220 (28)

CITY OF UKIAH TRENCH DETAIL SEWER LINE DRAWING NO. 220 FEB. '87

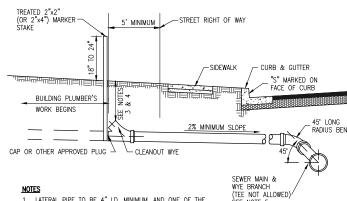

LATERAL PIPE TO BE 4" I.D. MINIMUM, AND ONE OF THE FOLLOWING MATERIALS:
 A) CAST IRON PIPE
 A) CAST IRON PIPE
 A) CAST IRON PIPE

B) ASBESTOS CEMENT PIPE, CLASS 2400

- B) ASBESIOS LEMENT PIPE, CLASS 2400
  C) POLYMINI, CHLORIDE (PVC), SDR-35
  2. 2% MINIMUM SLOPE GRADE EXCEPT WHERE A VARIATION
  IS SPECIFICALLY APPROVED BY THE CITY ENGINEER.
  3. DEPTH OF SERVICE LATERAL AT RIGHT OF WAY, IN NO
  CASE, SHALL BE LESS THAN 3', HOWEVER SUFFICIENT
  DEPTH SHALL BE PROVIDED TO ADEQUATELY SERVE THE
  DEPTH SHALL BE LESS THAN 3', ADEQUATELY SERVE THE
- BUILDING SITE.

  4. IN SOME CASES, THE ENGINEER MAY BE REQUIRED TO STAKE THE LATERAL INVERT AT RIGHT OF WAY. 5. MINIMUM INVERT ELEVATION OF WYE BRANCH EQUALS
- CENTERLINE OF SEWER MAIN. FOR SERVICE LATERAL TRENCH DETAILS SEE STANDARD DRAWING NO. 220.

(30)

CITY OF UKIAH SEWER SERVICE LATERAL (INITIAL CONSTRUCTION) DRAWING NO. 210 JUL '91



ATE: REVISION: BY: V17/17 REVISIONS TO TYPICAL SECTIONS/VOLUMES MAW /12/17 RAISE SD BY 1'±, MOVE CLAY ST CURB INLETS MAW 9/18/17 RAISE CLAY ST./COURTHOUSE BLVD 0.2±, MAW /27/17 WATER TO SS PROFILE-RAISE MH#1,ADD LATERALS MAW 10/6/17 AS-BUILT FIBER OPTIC, LOWER WATERLINE TO MISS MAW

5/26/18 FINAL CONSTRUCTION PLANS

VERIFY SCALE PATH: \DRAWINGS\FINAL FILE: R11003.5 Sanitary Sew-D PSVIEW: SHT26-SS Details USE OF THIS DOCUMENT, INCLUDING THE INCORPORATED DESIGNS, IS AN INSTRUMENT OF SERVICE FOR THIS PROJECT AND SHALL NOT BE USED FOR ANY OTHER PROJECT WITHOU THE WRITTEN AUTHORIZATION OF RAU AND ASSOCIATES INC

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309 EAST PERKINS STREET UKIAH, CA 95482




CIVIL ENGINEERS · LAND SURVEYORS 100 NORTH PINE STREET • (707) 462-6536 • UKIAH, CA 9548

SANITARY SEWER DETAILS DRAWING:

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	O, 11 17		oewer be	• • •			Scale:	AS	SHOWN
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PROJECT: COURT	HOUSE	INFR	ASTRUCTUR	F	PRO	JECT	Checked:		G.C.R.
			TRUCTION	_	1 110	o L O i	Reviewed:		G.C.R.

Date: JULY 2017 SHEET 26

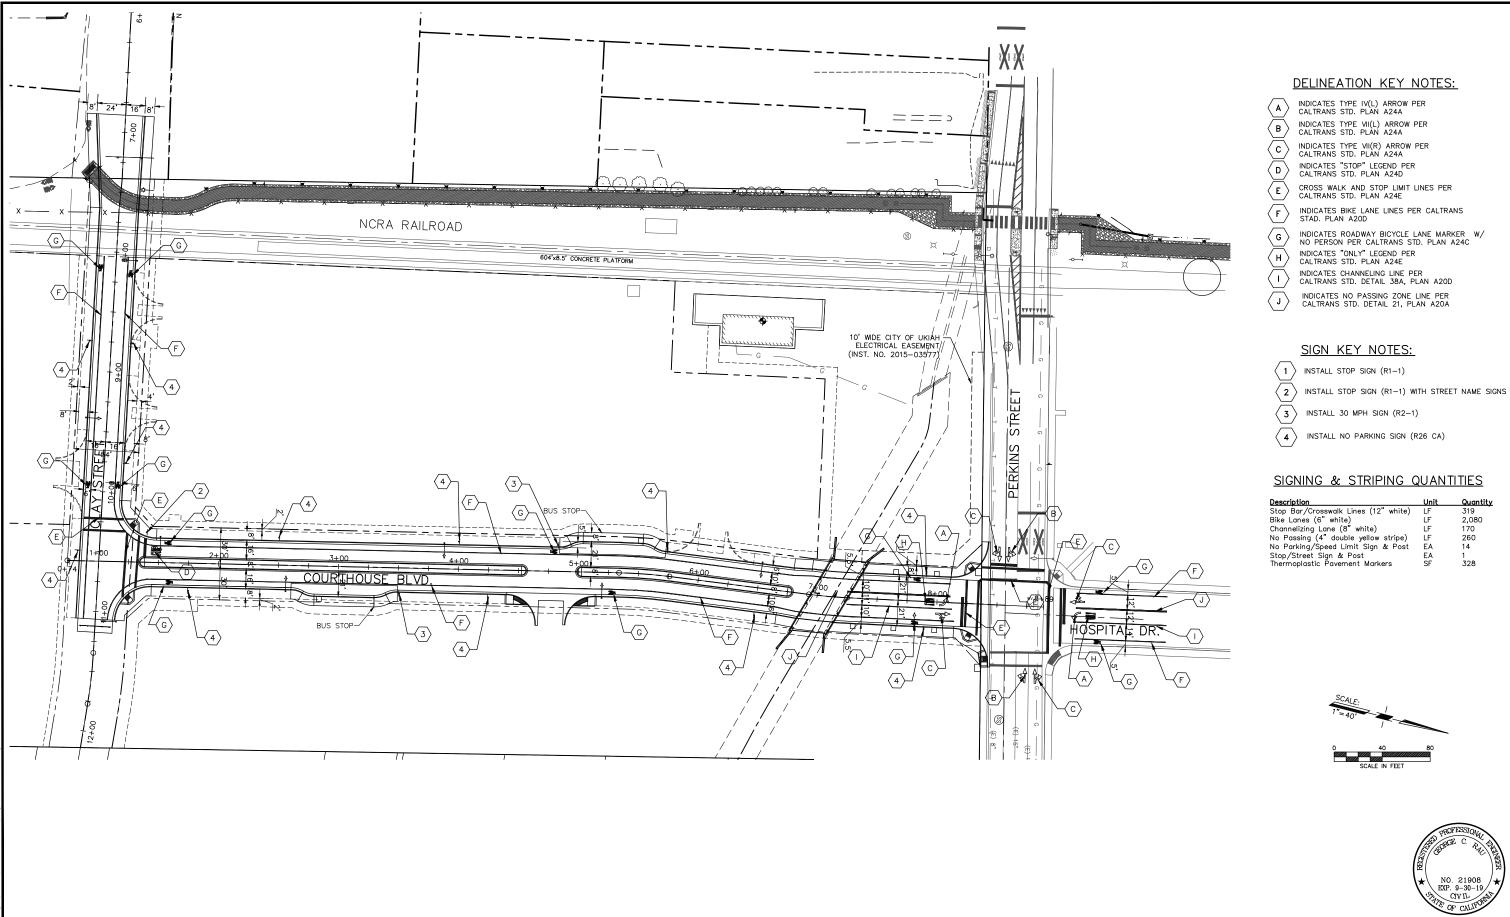

DATE: REVISION:

DATE: BY: COMPUTER NO: SERVER Z:\R11003.5

7/17/17 REVISIONS TO TYPICAL SECTIONS/VOLUMES MAW PATH: \DRAWNING\\Final Path: \DRAWNING\Final Path: \DRAWNING\\Final Path: \DRAWNING\Final Path: \DRAW

26/18 FINAL CONSTRUCTION PLANS

COMPUTER NO: SERVER Z:\R11003.5

PATH: \DRAWINGS\FINAL

FILE: R11003.5\_Striping\_Plan\_Final.dwg

PSVIEW: SHT27\_SIGN\_STRIPING

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OWNER: NORTH COAST RAILROAD AUTHORITY APN: 002-232-15 and 002-282-20

309 EAST PERKINS STREET

UKIAH, CA 95482

RAU AND ASSOCIATES INC.

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RAWING: SIGN and STRIPING PLAN

PROJECT: COURTHOUSE INFRASTRUCTURE PROJECT FINAL CONSTRUCTION

Date: JULY 2017
Scale: AS SHOWN
Drawn: M.A.W.
Checked: G.C.R.
Reviewed: G.C.R.
Ich No. 811003.5